

	Medical University of South Carolina Amendment 3	Solicitation Number	Q191100ADD
		Date Printed	January 3, 2019
		Date Issued	January 3, 2019
		Procurement Officer	Angie DeVeaux
		Phone	843-792-2389
		E-Mail Address	deveauan@muscd.edu

DESCRIPTION: **Fabricate and Install Steel Beam-W8x18**
 USING GOVERNMENTAL UNIT: Medical University of South Carolina

The Term "Offer" Means Your "Bid" or "Proposal".

SUBMIT OFFER BY (Opening Date/Time): **January 22, 2019 @ 10:00PM(EST)** (Local) See "Deadline for Submission of Offer" provision

QUOTATIONS MAY BE FAXED TO: 843-792-3884

QUESTIONS MUST BE RECEIVED BY: **January 16, 2019 @ 10:00AM(EST)** See "Questions From Offeror" provision

NUMBER OF COPIES TO BE SUBMITTED: **One COPY**

SUBMIT YOUR OFFER TO THE FOLLOWING ADDRESS:

PHYSICAL ADDRESS:
 Medical University of South Carolina
 University Purchasing
 19 Hagood Avenue, Suite 408
 Charleston, SC 29425

See "Submitting Your Offer" provision

CONFERENCE TYPE: Site Visit(Not Mandatory) DATE & TIME: January 15, 2019 at 10:00am(EST) Please bring your certificate of insurance. As appropriate, see "Conferences - Pre-Bid/Proposal" & "Site Visit" provisions		LOCATION: MUSC Engineering & Facilities 2nd floor Room PG203B Small conference room 97 Johnathan Lucas Street Charleston, SC 29425	
AWARD & AMENDMENTS	Award will be posted at the Physical Address stated above on 01/22/19 . The award, this solicitation, and any amendments will be posted at the following web address: https://web.musc.edu/about/leadership/institutional-offices/finance/vendor-portal/solicitations		
You must submit a signed copy of this form with Your Offer. By submitting a bid or proposal, You agree to be bound by the terms of the Solicitation. You agree to hold Your Offer open for a minimum of thirty (30) calendar days after the Opening Date.			
NAME OF OFFEROR		OFFEROR'S TYPE OF ENTITY:	
(Full legal name of business submitting the offer)		(Check one)	
AUTHORIZED SIGNATURE		<input type="checkbox"/> Sole Proprietorship <input type="checkbox"/> Partnership <input type="checkbox"/> Corporation (tax-exempt) <input type="checkbox"/> Corporate entity (nontax-exempt) <input type="checkbox"/> Government entity (federal, state, or local) <input type="checkbox"/> Other _____	
(Person signing must be authorized to submit binding offer to enter contract on behalf of Offeror named above.)			
TITLE			
(Business title of person signing above)			
PRINTED NAME	DATE SIGNED		
(Printed name of person signing above)			
Instructions regarding Offeror's name: Any award issued will be issued to, and the contract will be formed with, the entity identified as the offeror above. An offer may be submitted by only one legal entity. The entity named as the offeror must be a single and distinct legal entity. Do not use the name of a branch office or a division of a larger entity if the branch or division is not a separate legal entity, <i>i.e.</i> , a separate corporation, partnership, sole proprietorship, etc.			
STATE OF INCORPORATION		(If offeror is a corporation, identify the state of Incorporation.)	
TAXPAYER IDENTIFICATION NO.			
(See "Taxpayer Identification Number" provision)			

COVER PAGE MMO (JAN. 2006)

PAGE TWO

(Return Page Two with Your Offer)

HOME OFFICE ADDRESS (Address for offeror's home office / principal place of business)	NOTICE ADDRESS (Address to which all procurement and contract related notices should be sent.) (See "Notice" clause)
	<div style="border-bottom: 1px solid black; margin-bottom: 5px;"></div> <div style="display: flex; justify-content: space-between; font-size: small;"> Area Code - Number - Extension Facsimile </div> <div style="border-bottom: 1px solid black; margin-bottom: 5px;"></div> <div style="font-size: small;">E-mail Address</div>
PAYMENT ADDRESS (Address to which payments will be sent.) (See "Payment" clause)	ORDER ADDRESS (Address to which purchase orders will be sent) (See "Purchase Orders and "Contract Documents" clauses)
<div style="font-size: small;"> <input type="checkbox"/> Payment Address same as Home Office Address <input type="checkbox"/> Payment Address same as Notice Address (check only one) </div>	<div style="font-size: small;"> <input type="checkbox"/> Order Address same as Home Office Address <input type="checkbox"/> Order Address same as Notice Address (check only one) </div>

ACKNOWLEDGMENT OF AMENDMENTS
 Offerors acknowledges receipt of amendments by indicating amendment number and its date of issue. (See "Amendments to Solicitation" Provision)

Amendment No.	Amendment Issue Date	Amendment No.	Amendment Issue Date	Amendment No.	Amendment Issue Date	Amendment No.	Amendment Issue Date

DISCOUNT FOR PROMPT PAYMENT (See "Discount for Prompt Payment" clause)	10 Calendar Days (%)	20 Calendar Days (%)	30 Calendar Days (%)	____ Calendar Days (%)
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PREFERENCES - A NOTICE TO VENDORS (SEP. 2009): On June 16, 2009, the South Carolina General Assembly rewrote the law governing preferences available to in-state vendors, vendors using in-state subcontractors, and vendors selling in-state or US end products. This law appears in Section 11-35-1524 of the South Carolina Code of Laws. A summary of the new preferences is available at www.procurement.sc.gov/preferences. ***ALL THE PREFERENCES MUST BE CLAIMED AND ARE APPLIED BY LINE ITEM, REGARDLESS OF WHETHER AWARD IS MADE BY ITEM OR LOT. VENDORS ARE CAUTIONED TO CAREFULLY REVIEW THE STATUTE BEFORE CLAIMING ANY PREFERENCES. THE REQUIREMENTS TO QUALIFY HAVE CHANGED. IF YOU REQUEST A PREFERENCE, YOU ARE CERTIFYING THAT YOUR OFFER QUALIFIES FOR THE PREFERENCE YOU'VE CLAIMED. IMPROPERLY REQUESTING A PREFERENCE CAN HAVE SERIOUS CONSEQUENCES.*** [11-35-1524(E)(4)&(6)]

PREFERENCES - ADDRESS AND PHONE OF IN-STATE OFFICE: Please provide the address and phone number for your in-state office in the space provided below. An in-state office is necessary to claim either the Resident Vendor Preference (11-35-1524(C)(1)(i)&(ii)) or the Resident Contractor Preference (11-35-1524(C)(1)(iii)). Accordingly, you must provide this information to qualify for the preference. An in-state office is not required, but can be beneficial, if you are claiming the Resident Subcontractor Preference (11-35-1524(D)).

☐ In-State Office Address same as Home Office Address
☐ In-State Office Address same as Notice Address (check only one)

AMENDMENTS TO SOLICITATION (JAN 2004): (a) The Solicitation may be amended at any time prior to opening. All actual and prospective Offerors should monitor the following web site for the issuance of Amendments: <http://academicdepartments.musc.edu/vpfa/finance/purchasingap/index.htm> Vendors Toolkit Solicitation (b) Offerors shall acknowledge receipt of any amendment to this solicitation (1) by signing and returning the amendment, (2) by identifying the amendment number and date in the space provided for this purpose on Page Two, (3) by letter, or (4) by submitting a bid that indicates in some way that the bidder received the amendment. (c) If this solicitation is amended, then all terms and conditions which are not modified remain unchanged.[02-2A005-1]

Questions and Answers:

1. Will we allowed to utilize a fork lift in that area?

Not inside the building but on sidewalks or roadways that are wide enough to accommodate the forklift.

2. What is the duration time once purchase order is cut

All work must be completed by April 1, 2019

3. If the beam doesn't fist directly underneath the existing beam is there an alternate detail for he hanger?

See attached updated drawing revised 01/17/2019

- **S201 sheet 3 and S202 sheet 4 revised 01/17/2019 alternatives on hangers**
- **S201 sheet 3 revised 01/17/2019 for splice instructions**

4. If testing or inspection of the welds to be conducted we will not be responsible for the this cost correct.

- **All welding must be done according to American Welding Society standards of quality, AWS D1.1. as per Drawing Field Welding Note #1, Sheet 1.**
- **If required by owner, Third party inspections will be paid for by the owner (as per Drawing Field Welding Note #1, Sheet 10)**

5. Are the shop drawings required to be stamped?

They do not need to be signed and sealed and they need to be submitted for review and approval prior to fabrication.

6. Will MUSC be allocating parking spaces for at least two spaces for vehicles for the duration of this project?

Parking can be arranged for 2 vehicles

STRUCTURAL ABBREVIATIONS

AB	A. BOLT	IN	INCH
ADJ	ADJACENT	INCL	INCLUDE, ING
AFF	ABOVE FINISHED FLOOR	INT	INTERIOR
AHU	AIR HANDLING UNIT	LB	POUND
ALUM	ALUMINUM	LG	LONG
ALT	ALTERNATE	LL	LIVE LOAD
APPD	APPROVED	LLBB	LONG LEG BACK TO BACK
APPROX	APPROXIMATE	LLH	LONG LEG HORIZONTAL
ARCH	ARCHITECT	LLV	LONG LEG VERTICAL
		LONG	LONGITUDINAL
		LSL	LONG SLOTTED HOLES
		LT	LIGHT
		LTWT	LIGHTWEIGHT
B/	BOTTOM OF	MAS	MASONRY
BLDG	BUILDING	MAX	MAXIMUM
BM	BEAM	MECH	MECHANICAL
BOT	BOTTOM	MEZZ	MEZZANINE
BRDG	BRIDGING	MFR	MANUFACTURER
BRG	BEARING	MID	MIDDLE
BLK	BLOCK	MIN	MINIMUM
BTWN	BETWEEN	MISC	MISCELLANEOUS
		MJ	MASONRY JOINT
		MO	MASONRY OPENING
CANT	CANTILEVER	N	NORTH
C/C	CENTER TO CENTER	NIC	NOT IN CONTRACT
CHAM	CHAMFER	NO	NUMBER NOM NOMINAL
CIRC	CIRCULAR	NS	NEAR SIDE
CJ	CONTROL JOINT	NTS	NOT TO SCALE
CLR	CLEAR		
CMU	CONCRETE MASONRY UNITS	O/O	OUT TO OUT
COL	COLUMN	OC	ON CENTER
CONC	CONCRETE	OD	OUTSIDE DIAMETER
CONN	CONNECTION	OF	OUTSIDE FACE
CONX	CONNECTION	OPNG	OPENING
CONST	CONSTRUCTION	OPP	OPPOSITE
CONT	CONTINUOUS	OW	OPEN WEB
CONTR	CONTRACTOR	PAF	POWDER ACTUATED FASTENER
COORD	COORDINATE	PL	PLATE
CTRD	CENTERED	PLF	POUNDS PER LINEAL FOOT
		PROJ	PROJECTION
D	DEPTH	PSF	POUNDS PER SQUARE FOOT
DBL	DOUBLE	PSI	POUNDS PER SQUARE INCH
DET	DETAIL	PT	PRESSURE TREATED
DIA	DIAMETER	RAD	RADIUS
DIAG	DIAGONAL	REF	REFERENCE
DIM	DIMENSION	REINF	REINFORCEMENT
DL	DEAD LOAD	RET	RETURN
DWGS	DRAWINGS	REV	REVISION
		RP	RADIUS POINT
E	EAST	RT	RIGHT
EA	EACH	RTU	ROOF TOP UNIT
EB	EXPANSION BOLT		
EF	EACH FACE	S	SOUTH
EJ	EXPANSION JOINT	SA	SLEEVE ANCHOR
EL	ELEVATION	SB	SLAB BOLSTER
ELEV	ELEVATOR	SCHED	SCHEDULE
EMBED	EMBEDMENT	SECT	SECTION
ENGR	ENGINEER	SF	STEP FOOTING
EOS	EDGE OF SLAB	SIM	SIMILAR
EQ	EQUAL	SPEC	SPECIFICATIONS
EQUIP	EQUIPMENT	SP	SPACING,ES
EQUIV	EQUIVALENT	SQ	SQUARE
ES	EACH SIDE	SSL	SHORT SLOTTED HOLES
EW	EACH WAY	SS	STAINLESS STEEL
EXP	EXPANSION	STD	STANDARD
EXIST	EXISTING	STIFF	STIFFENERS
EXT	EXTERIOR	STL	STEEL
		STRL	STRUCTURAL
		SYMM	SYMMETRICAL
FC	FILLED CELL		
FF	FINISHED FLOOR	T/	TOP OF
FIN	FINISH	TB	TIE BEAM
FLR	FLOOR	TC	TIE COLUMN
FDN	FOUNDATION	TCX	TOP CHORD EXTENSION
FRG	FRAMING	T&B	TOP AND BOTTOM
FT	FEET	TEMP	TEMPORARY
FTG	FOOTING	TRAN	TRANSVERSE
FV	FIELD VERIFY	TS	TUBE STEEL
		TYP	TYPICAL
		TD	PRESSURE TREATED
GALV	GALVANIZED	UNO	UNLESS NOTED OTHERWISE
GA	GAUGE	VERT	VERTICAL
HORIZ	HORIZONTAL	W	WEST
HSA	HEADED STUD ANCHOR	WTH	WIDTH
HSB	HIGH STRENGTH BOLT	W/	WITH
HT	HEIGHT	W/O	WITHOUT
		WP	WORK POINT
		WS	WATERSTOP
ID	INSIDE DIAMETER	WT	WEIGHT
IF	INSIDE FACE	WWF	WELDED WIRE FABRIC

GENERAL NOTE:

THE G.C. SHALL FIELD VERIFY ALL EXISTING STEEL ELEVATIONS AND DIMENSIONS

THE G.C. SHALL COORD. NEW EQUIPMENT LAYOUT W/ EXISTING STEEL.

THE G.C. SHALL COORD. FOLDING PARTITION DOOR EQUIPMENT LAYOUT AND ATTACHMENT TO NEW STEEL PRIOR TO STEEL FABRICATION.

ALL ITEMS SHALL BE VERIFIED PRIOR TO NEW STEEL FABRICATION.

STRUCTURAL DESIGN CRITERIA

1. GRAVITY LOAD DESIGN VALUES: IBC–2015/ ASCE 7–10
- LIVE LOADS:
- | | |
|------------------------|----------------------|
| OFFICES | 50–PSF |
| CORRIDOR | 80–PSF |
| FOLDING PARTITION DOOR | 125–LB/LF MAX WEIGHT |
- SEE PLAN FOR ADDITIONAL FLOOR AND ROOF LIVE LOAD LOADING REQUIREMENTS.

- DEAD LOADS:
- ACTUAL MATERIAL WEIGHTS

- SOIL BEARING PRESSURE, (ALLOWABLE): PILE FOUNDATION (EXISTING, ASSUMED)

2. SEISMIC DESIGN VALUES: IBC–2015/ ASCE 7–10
- Ss = 1.126g, Sds = 0.788g
- S1 = 0.358g, Sd1 = 0.402g
- SITE CLASS: "D"
- BUILDING CATEGORY: "III"
- SEISMIC DESIGN CATEGORY: "D"
- SEISMIC FORCE RESISTING SYSTEM (EXISTING CHP BUILDING): ASCE 7–10
- SPECIALLY REINFORCED CONCRETE SHEAR WALLS (EXISTING, ASSUMED)
- R = 6 (EXISTING SYSTEM, ASSUMED)
- Cd = 5 (EXISTING SYSTEM, ASSUMED)
- I = 1.25 (EXISTING SYSTEM, ASSUMED)
- TL – 8.0 (EXISTING SYSTEM, ASSUMED)
- Cs = .164 (EXISTING SYSTEM, ASSUMED)

- SEISMIC FORCE ON NONSTRUCTURAL COMPONENT (FOLDING PARTITION DOOR): ASCE 7–10 (CHAPTER 13&15)

- FOLDING PARTITION DOOR
- Rp = 2.5
- op = 1.0
- lp = 1.5
- Fp = 2.24 KIPS

3. WIND LOAD DESIGN VALUES: IBC–2015 (MWFRS)/ ASCE 7–10 (MWFRS)
- V(ult) = 158 mph (3–sec gust) (MWFRS)
- EXPOSURE CATEGORY: "B"
- BUILDING CATEGORY: "III"
- I = 1.00
- Gcpi = +/- .18
- q(ult) = 44.0 – PSF q̄(ult) = 7.9 – PSF

GENERAL NOTES:

- STRUCTURAL DRAWINGS SHALL BE USED IN CONJUNCTION WITH ARCHITECTURAL AND MECHANICAL DRAWINGS AND DRAWINGS RELATING TO OTHER TRADES. CONTRACTOR SHALL BE RESPONSIBLE FOR CHECKING AND COORDINATING DIMENSIONS, CLEARANCES, ETC. WITH THE WORK OF OTHER TRADES. IN CASE OF CONFLICT BETWEEN DRAWINGS, THE MORE STRINGENT REQUIREMENT SHALL GOVERN.
- IN CASE OF CONFLICT BETWEEN THE DRAWINGS, NOTES AND SPECIFICATIONS, THE SPECIFICATIONS SHALL GOVERN.
- WORK NOT INDICATED ON A PART OF THE DRAWINGS BUT REASONABLY IMPLIED TO BE SIMILAR TO THAT SHOWN AT CORRESPONDING PLACES SHALL BE REPEATED.
- REVIEW ALL PROJECT DOCUMENTS PRIOR TO FABRICATION AND START OF CONSTRUCTION. REPORT ANY DISCREPANCIES TO A/E PRIOR TO PROCEEDING WITH WORK.
- IT IS THE PRIME CONTRACTOR'S RESPONSIBILITY TO PROTECT EXISTING FACILITIES, STRUCTURES AND UTILITY LINES FROM ALL DAMAGE DURING CONSTRUCTION.
- COORDINATE STRUCTURAL AND OTHER DRAWINGS THAT ARE PART OF THE CONTRACT DOCUMENTS FOR ANCHORED, EMBEDDED OR SUPPORTED ITEMS WHICH MAY AFFECT THE STRUCTURAL DRAWINGS.
- ALL DETAILS AND SECTIONS ON THE DRAWINGS ARE INTENDED TO BE TYPICAL AND SHALL BE CONSTRUED TO APPLY TO ANY SIMILAR SITUATION ELSEWHERE ON THE PROJECT EXCEPT WHERE A SEPARATE DETAIL IS SHOWN.
- USE OF CONTRACT DRAWINGS REPRODUCED IN WHILE OR ANY PART IN SHOP DRAWING SHALL NOT RELIEVE THE CONTRACTOR OR SUBCONTRACTORS FROM THEIR RESPONSIBILITY TO ACCURATELY LAYOUT, COORDINATE, DETAIL, FABRICATE AND INSTALL A COMPLETE STRUCTURE.
- REVIEW ALL SHOP DRAWINGS FOR CONFORMANCE WITH THE CONTRACT DOCUMENTS AND FOR COMPLETENESS AND ANSWER ALL CONTRACTOR RELATED QUESTIONS. STAMP AND INITIAL ALL SHEETS PRIOR TO SUBMITTING SHOP DRAWINGS TO OR A/E FOR REVIEW.

STRUCTURAL STEEL:

- ALL STRUCTURAL STEEL WORK SHALL CONFORM TO THE SPECIFICATIONS FOR THE DESIGN, FABRICATION, AND ERECTION OF STRUCTURAL STEEL FOR BUILDINGS, CURRENT EDITION, OF THE A.I.S.C.
- WELDS, BOTH SHOP AND FIELD, SHALL CONFORM TO THE A.W.S SPECIFICATIONS. ALL WELDS SHALL BE DONE WITH E–70 ELECTRODES
- STRUCTURAL STEEL SHOP DRAWINGS ARE REQUIRED AND SHALL BE SUBMITTED TO THE A/E FOR APPROVAL PRIOR TO FABRICATION. SHOP DRAWINGS SHALL NOT BE A REPRODUCTION OF THE CONTRACT DOCUMENTS. THE GENERAL CONTRACTOR SHALL REVIEW AND STAMP ALL SHOP DRAWINGS AND SUBMITTALS "APPROVED" PRIOR TO SUBMITTING TO ARCHITECT FOR REVIEW.
- (NOTE NOT USED.)
- STRUCTURAL STEEL MATERIALS SHALL CONFORM TO THE FOLLOWING ASTM SPECIFICATION (U.N.O.):
- WIDE FLANGES, STRUCTURAL TIES ASTM A992, FY=50 KSI
- ANGLES, PLATES, MISC. STEEL ASTM A36, FY=36 KSI
- THRD'D RODS ASTM A36, FY=36 KSI
- TUBES/HSS ASTM A500,GRADE B
- PIPES ASTM A53, TYPE E OR S,
- ANCHOR BOLTS ASTM A449
- HIGH STRENGTH BOLTS ASTM A325 TYPE 1
- PROVIDE STIFFENER PLATES ON EACH SIDE OF WEB, BEAM OR GIRDER AT POINTS OF CONCENTRATED LOADS. MINIMUM STIFFENER PLATE THICKNESS SHALL BE 1/2" OR FLANGE THICKNESS OF SUPPORTING MEMBER, WHICHEVER IS GREATER, U.N.O.
- PROVIDE TEMPORARY BRACING OR GUYS TO PROVIDE LATERAL SUPPORT UNTIL PERMANENT LATERAL BRACING IS INSTALLED.
- THE PRIME CONTRACTOR SHALL PROVIDE WEB REINFORCEMENT AT OPENINGS IN STEEL BEAMS AND GIRDERS FOR MECHANICAL AND ELECTRICAL PENETRATIONS IF INDICATED ON MECHANICAL, STRUCTURAL OR ELECTRICAL DRAWINGS. ALL OPENINGS SHALL BE LOCATED AT THE CENTER OF THE BEAM WEB DEPTH.
- THE PRIME CONTRACTOR SHALL COORDINATE THE BOTTOM OF BASE PLATE ELEVATION WITH THE TOP OF CONCRETE ELEVATION. IN CASE OF CONFLICT, THE CONTRACTOR SHALL MAKE ALLOWANCE IN HIS BID FOR THE MORE STRINGENT REQUIREMENT.
- CUTS, HOLES, COPING, ETC. REQUIRED FOR WORK OF OTHER TRADES SHALL BE SHOWN ON THE SHOP DRAWINGS AND MADE IN THE SHOP. CUTS OR BURNING HOLES IN STRUCTURAL STEEL MEMBERS IN THE FIELD WILL NOT BE PERMITTED.
- ALL STEEL DETAILS AND CONNECTIONS SHALL BE IN ACCORDANCE WITH THE REQUIREMENT OF THE AISC SPECIFICATIONS (LATEST EDITION), INCLUDING ALL SUPPLEMENTS AND REVISIONS.
- SHOP CONNECTIONS NOT SPECIFICALLY DETAILED ON THE DRAWINGS MAY BE WELDED OR BOLTED UPON APPROVAL OF THE A/E. FIELD CONNECTIONS NOT SPECIFICALLY DETAILED ON THE DRAWING SHALL BE BOLTED UPON APPROVAL OF THE A/E.
- BEAM CONNECTIONS SHALL BE 3/4" DIAMETER A325 TYPE CONNECTION BOLT UNLESS OTHERWISE NOTED. ALL BEAM AND GIRDER CONNECTIONS, UNLESS SHOWN OTHERWISE, SHALL BE AT LEAST CAPABLE OF DEVELOPING THE UNIFORMLY DISTRIBUTED LOADING CAPACITY OF MEMBER OF ITS SPAN AS PER AISC MANUAL OF STEEL CONSTRUCTION (LATEST EDITION).
- ALTERNATE CONNECTION DETAILS MAY BE USED IF SUCH DETAILS ARE SUBMITTED TO THE A/E FOR REVIEW AND ACCEPTANCE IS GRANTED. HOWEVER, THE A/E SHALL BE THE SOLE JUDGE OF ACCEPTABILITY AND THE PRIME CONTRACTOR'S BID SHALL ANTICIPATE THE USE OF THESE SPECIFIC DETAILS SHOWN ON THE DRAWINGS. IN ANY EVENT, THE CONTRACTOR SHALL BE RESPONSIBLE FOR THE DESIGN OF SUCH ALTERNATE DETAILS WHICH HE PROPOSES.
- FOR LOCATION OF LINTELS, SEE ARCHITECTURAL DRAWINGS. FOR SIZE OF LINTELS, SEE SCHEDULE. HUNG LINTELS SHALL BE PROVIDED AND INSTALLED BY STRUCTURAL STEEL CONTRACTOR. LOOSE LINTELS SHALL BE SUPPLIED AND INSTALLED BY MISCELLANEOUS IRON AND STEEL CONTRACTOR.
- STEEL FABRICATOR SHALL SUPPLY ANCHOR BOLT LOCATION DRAWINGS.
- BOTTOMS OF ALL COLUMNS SHALL BE MILLED.
- FILLET WELD SIZES NOT CALLED OUT HEREIN SHALL BE 3/16" MINIMUM.



FIELD WELDING:

- ALL FIELD WELDING SHALL BE IN ACCORDANCE WITH AWS D1.1 STRUCTURAL WELDING CODE (LATEST EDITION)
- WELDING SHALL BE PERFORMED BY QUALIFIED WELDERS. CONTRACTOR SHALL SUBMIT WELDING CERTIFICATES FOR APPROVAL.
- ALL WELDING ELECTRODES SHALL SHALL BE E70 WITH A MINIMUM YIELD STRENGTH OF 58KSI, MINIMUM TENSILE STRENGTH OF 70 KSI, AND MINIMUM ELONGATION OF 22% IN ACCORDANCE WITH AWS A5.
- FIELD WELDING SHALL BE SHOWN ON ERECTION DRAWINGS.
- REPAIR ALL DAMAGED PRIMER AT ADJACENT AREAS AFTER WELD INSPECTION IS COMPLETE.
- MINIMUM WELD FOR FRAMING AND MISCELLANEOUS STEEL SHALL BE 3/8" FILLET WELD ALL AROUND UNLESS NOTED OTHERWISE.
- ALL WELD FILLER METAL SHALL HAVE A MINIMUM CVN TOUGHNESS OF 20 FT–LBS AT MINUS 10 DEGREES FAHRENHEIT AND 40 FT–LB AT 70° FAHRENHEIT.
- THE PRIME CONTRACTOR SHALL SCHEDULE WELD TESTING AND INSPECTION SUCH THAT REPORTS MAY BE REVIEWED BY THE EOR AND APPROVAL OR RECOMMENDATION FOR FURTHER TESTING OR REMEDIAL ACTION MAY BE MADE WHILE WELDS ARE STILL ACCESSIBLE.
- SUBCONTRACTOR SHALL SUBMIT DETAIL WELD PROCEDURE FOR EACH TYPE OF WELD TO BE COMPLETED. INFORMATION SHALL BE MADE AVAILABLE TO THE WELD INSPECTOR.
- TESTING AND INSPECTION OF FIELD WELDS SHALL BE CONDUCTED BY AN INDEPENDENT TESTING AGENCY (COMMISSIONED BY THE OWNER) IN ACCORDANCE WITH THE SCHEDULE OF SPECIAL INSPECTIONS.

MUSCH CHP
Charleston, South Carolina

MUSC CHP 1ST FLOOR FOLDING PARTITION
DOOR (ROOM 105)

CHARLESTON
SOUTH CAROLINA

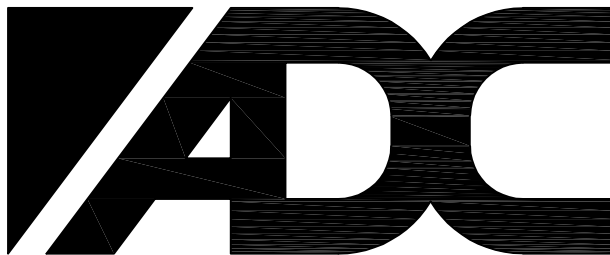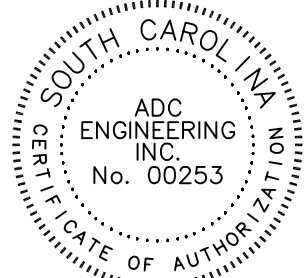

ENGINEERING SPECIALISTS


SITE SERVICES \ BUILDING ENVELOPE \ STRUCTURAL

1226 YEAMANS HALL ROAD
HANAHAN, SC 29410
843-566-0161
fax 843-566-0162
ADCENGINEERING.COM

DATE:	4-27-2018
ADC PROJECT #:	18026.0
DESIGNED:	CJG
CHECKED:	CJG
DRAWN:	VG
REVISION:	

GENERAL NOTES
AND
DESIGN CRITERIA

S000

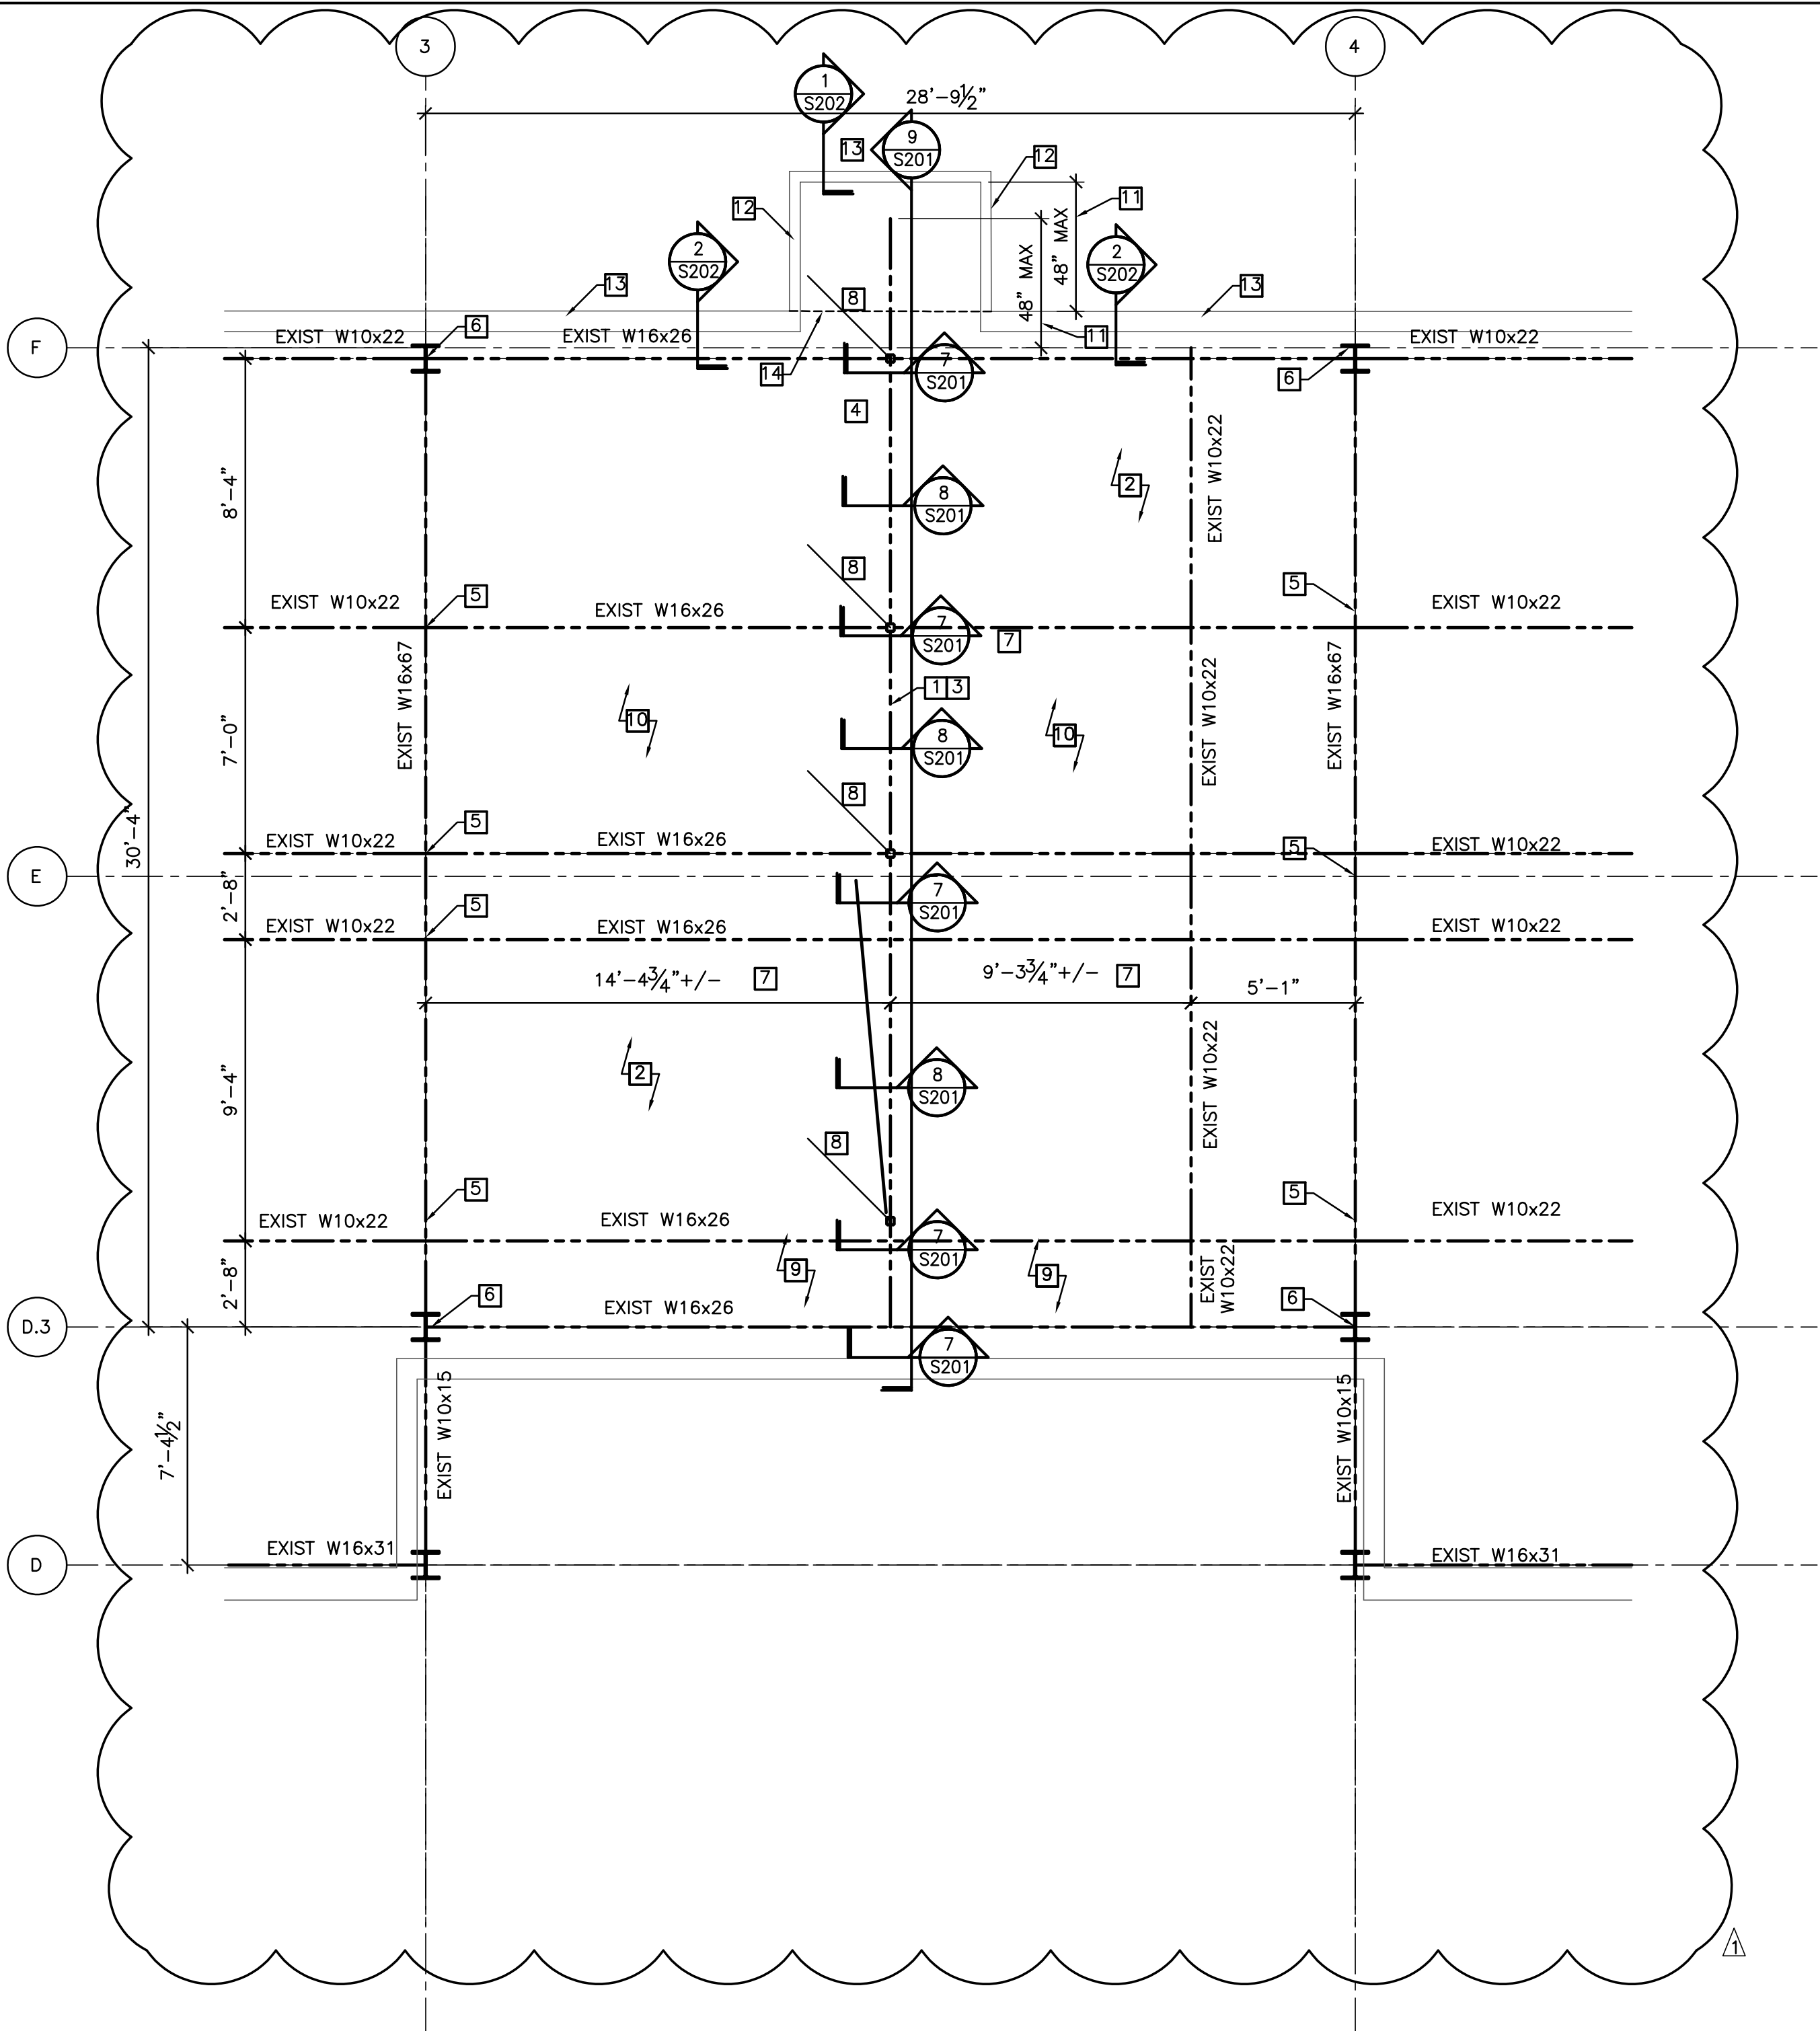

1 SECOND FLOOR FRAMING PLAN
SCALE: 1/4"=1'-0"

DRAWING NOTES:

- APPLY TO THIS DRAWINGS ONLY
- 1 NEW W8x18, CONT.
 - 2 EXISTING SLAB ABOVE
 - 3 MAXIMUM DOOR WEIGHT = 125-LBS/FT
 - 4 DOOR TO STACK IN THIS LOCATION. IF OWNER WANTS ALTERNATE LOCATION, NOTIFY EOR SO ALTERNATE PLAN MAY BE PROVIDED.
 - 5 PROVIDE ADDITIONAL WELD @ CONNECTION OF EXISTING BEAM TO EXISTING BEAM PER TYPICAL DETAIL 1/S201.
 - 6 PROVIDE ADDITIONAL WELD @ CONNECTION OF EXISTING BEAM TO EXISTING COLUMN PER TYPICAL DETAIL 4/S201.
 - 7 G.C. TO COORDINATE WITH OWNER FOR EXACT DOOR LOCATION.
 - 8 HSS 3x3x1/4 HANGER.
 - 9 G.C. TO REMOVE AND REPLACE GYP. CEILING AS REQUIRED. REPLACE TO MATCH EXISTING ADJACENT.
 - 10 G.C. TO REMOVE AND REPLACE DROP CEILING. REPLACE TO MATCH EXISTING ADJACENT.
 - 11 G.C. TO COORDINATE W/ DOOR SUPPLIER.
 - 12 362S162x20GA METAL STUDS @ 16"o.c.
 - 13 INFILL METAL STUD FRAMING W/ 362S162x20GA STUDS @ 16"o.c.
 - 14 G.C. SHALL MOVE CONDUIT & WIRING SO AS NOT TO INTERFERE W/ NEW BEAM & DOOR. G.C. TO FIELD LOCATE NEW CONDUIT & EXTENT.




ELEVATIONS:

T/1ST FLOOR SLAB	=	0'-0"
T/DOOR	=	9'-8½" ±
B/NEW BEAM (W8x18)	=	10'-3" ±
B/EXISTING CONDUIT	=	10'-11¼" ± G.C. TO F.V.
T/EXISTING W16x26	=	15'-1¼" ± G.C. TO F.V.

MUSCH CHP
Charleston, South Carolina

MUSC CHP 1ST FLOOR FOLDING PARTITION
DOOR (ROOM 105)

CHARLESTON
SOUTH CAROLINA

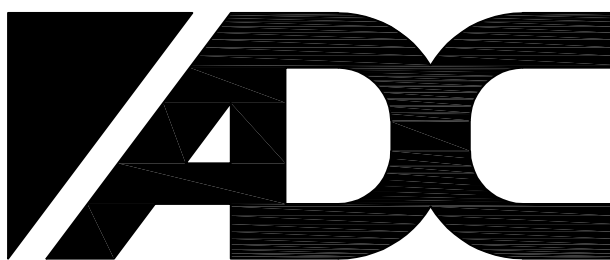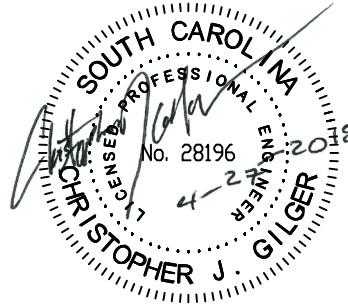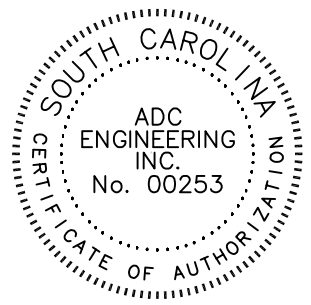

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SITE SERVICES \ BUILDING ENVELOPE \ STRUCTURAL

1224 YEAMANS HALL ROAD
HANAHAN, SC 29410
843-566-0161
fax 843-566-0162
ADCEngineering.com



DATE:	4-27-2018
ADC PROJECT #:	18026.0
DESIGNED:	CJG
CHECKED:	CJG
DRAWN:	VG
REVISION:	

REVISD 09.10.2018


SECOND FLOOR
FRAMING PLAN

S101

NOTE:
G.C. TO VERIFY CONNECTION IS MINIMUM 3/8" TAB PLATE, W/
3-3/4" A325 STD. BOLTS. IF CONNECTION IS NOT AS
INDICATED, NOTIFY A/E FOR ALTERNATE CONNECTION. G.C. TO
PROVIDE ALLOWANCE IN BID OF \$2000.00 PER CONNECTION FOR
ALTERNATE CONNECTION

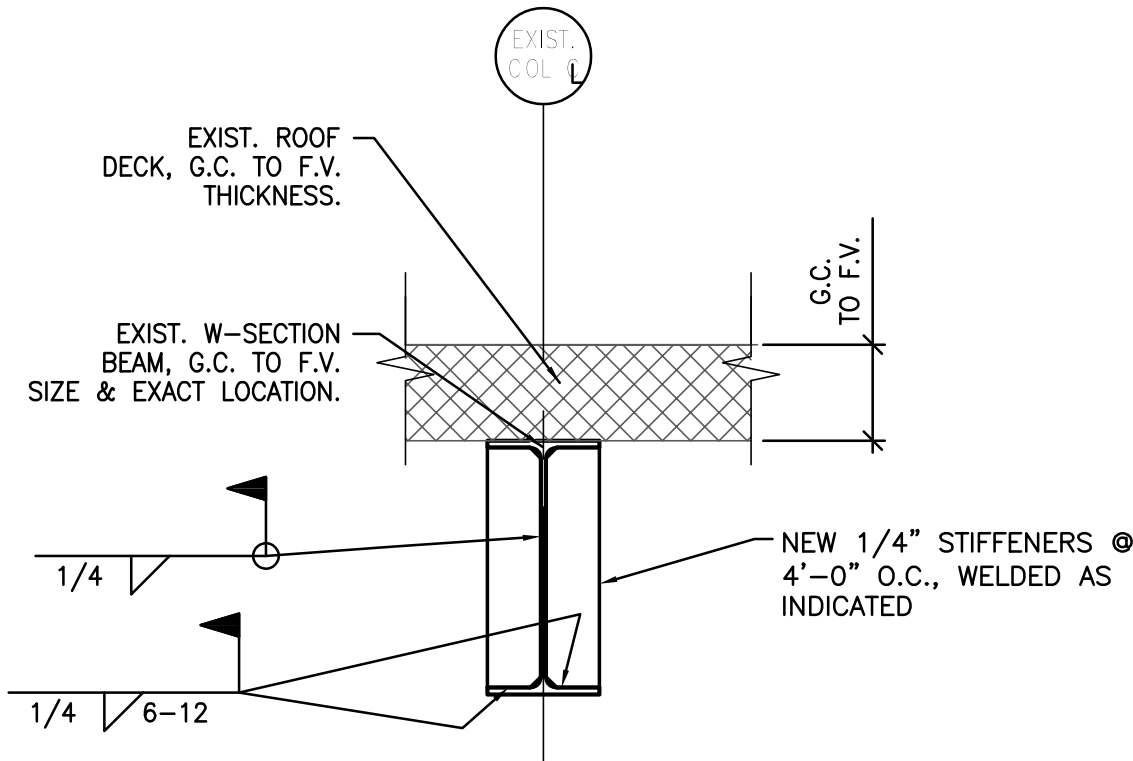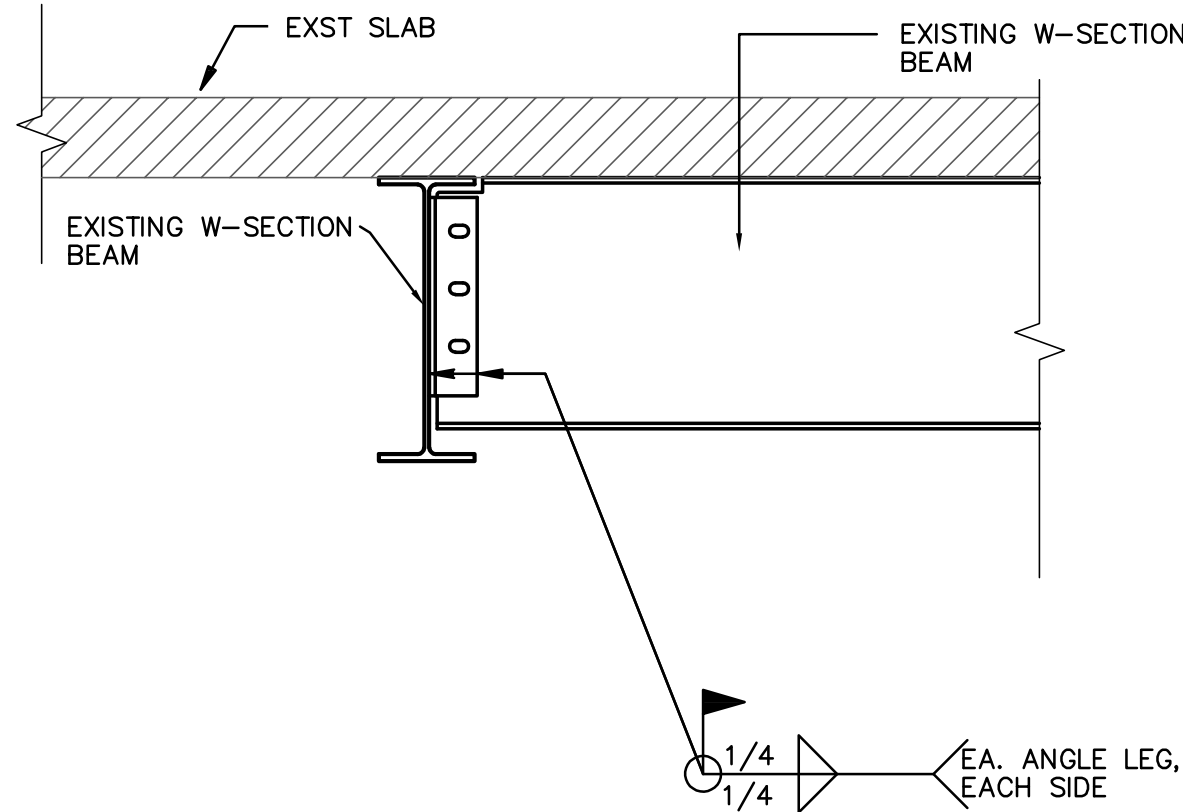

NOTE:
G.C. TO VERIFY CONNECTION IS MINIMUM 3/8"
TAB PLATE, W/ 4-3/4" A325 STD. BOLTS.
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A/E FOR ALTERNATE CONNECTION. G.C. TO
PROVIDE ALLOWANCE IN BID OF \$2000.00 PER
CONNECTION FOR ALTERNATE CONNECTION

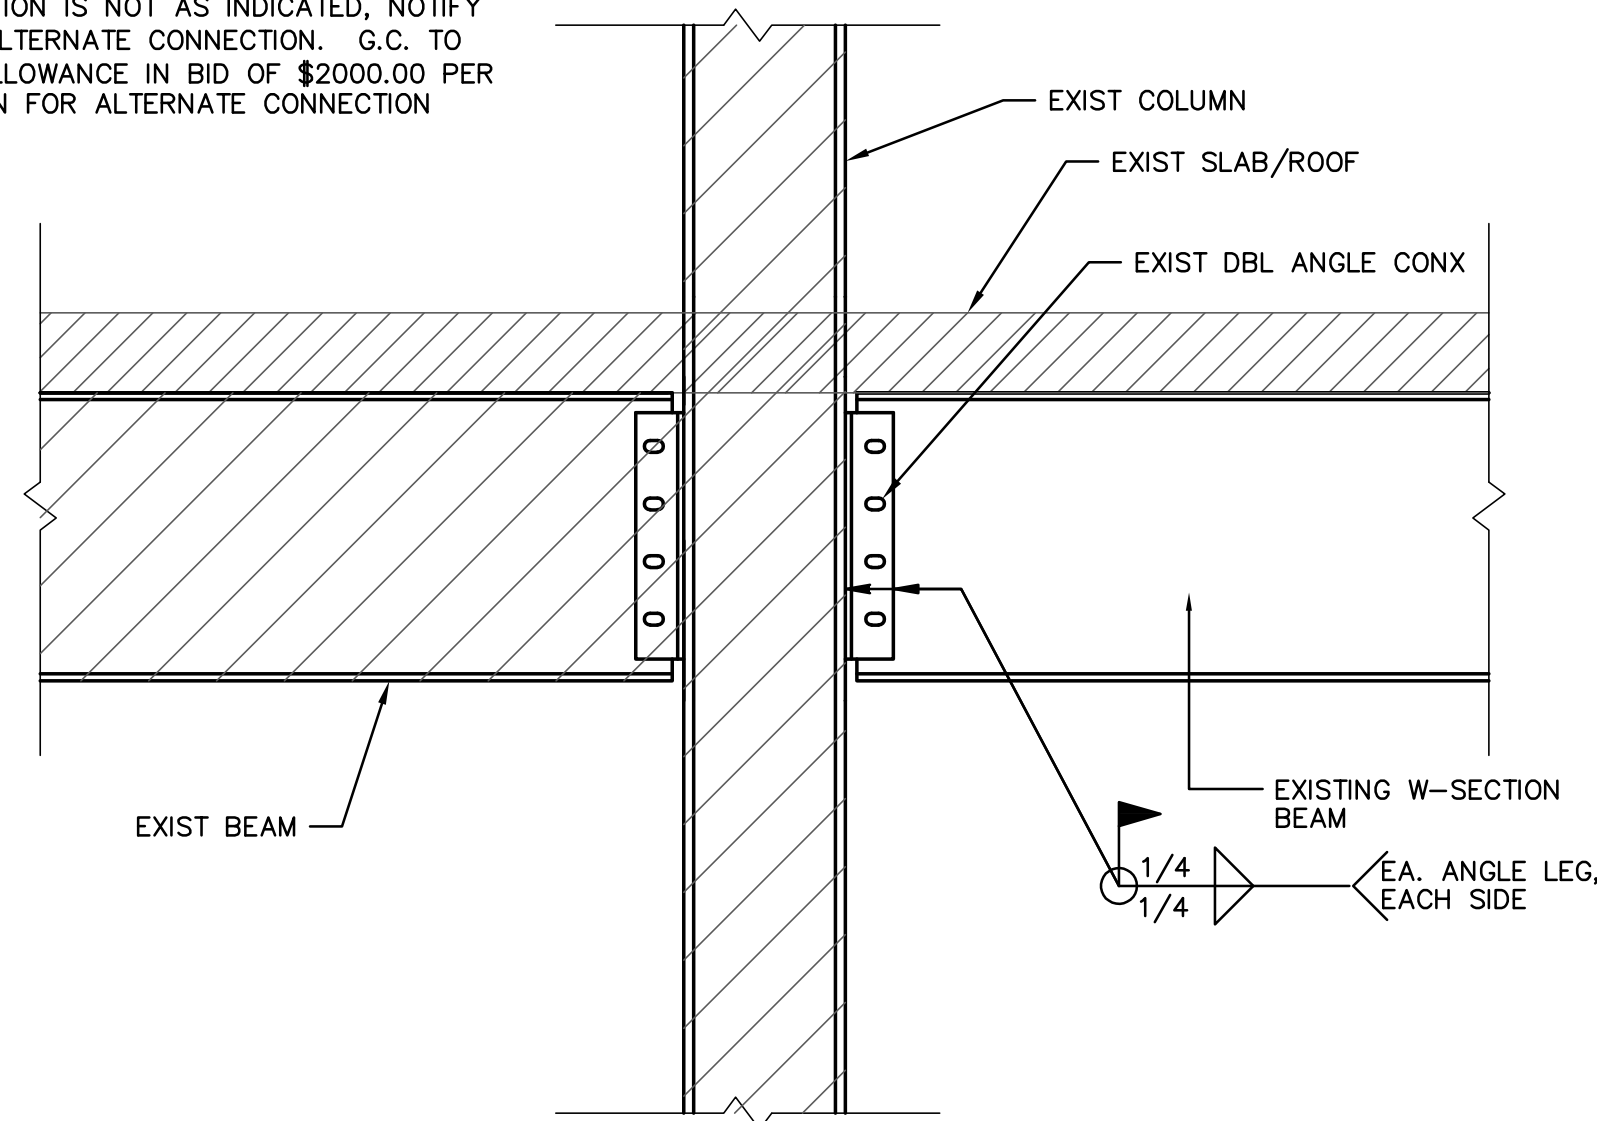

1 SECTION (TYPICAL)


SCALE: 1"=1'-0"

2 SECTION (TYPICAL)

SCALE: 1"=1'-0"


4 SECTION (TYPICAL)

SCALE: 1"=1'-0"

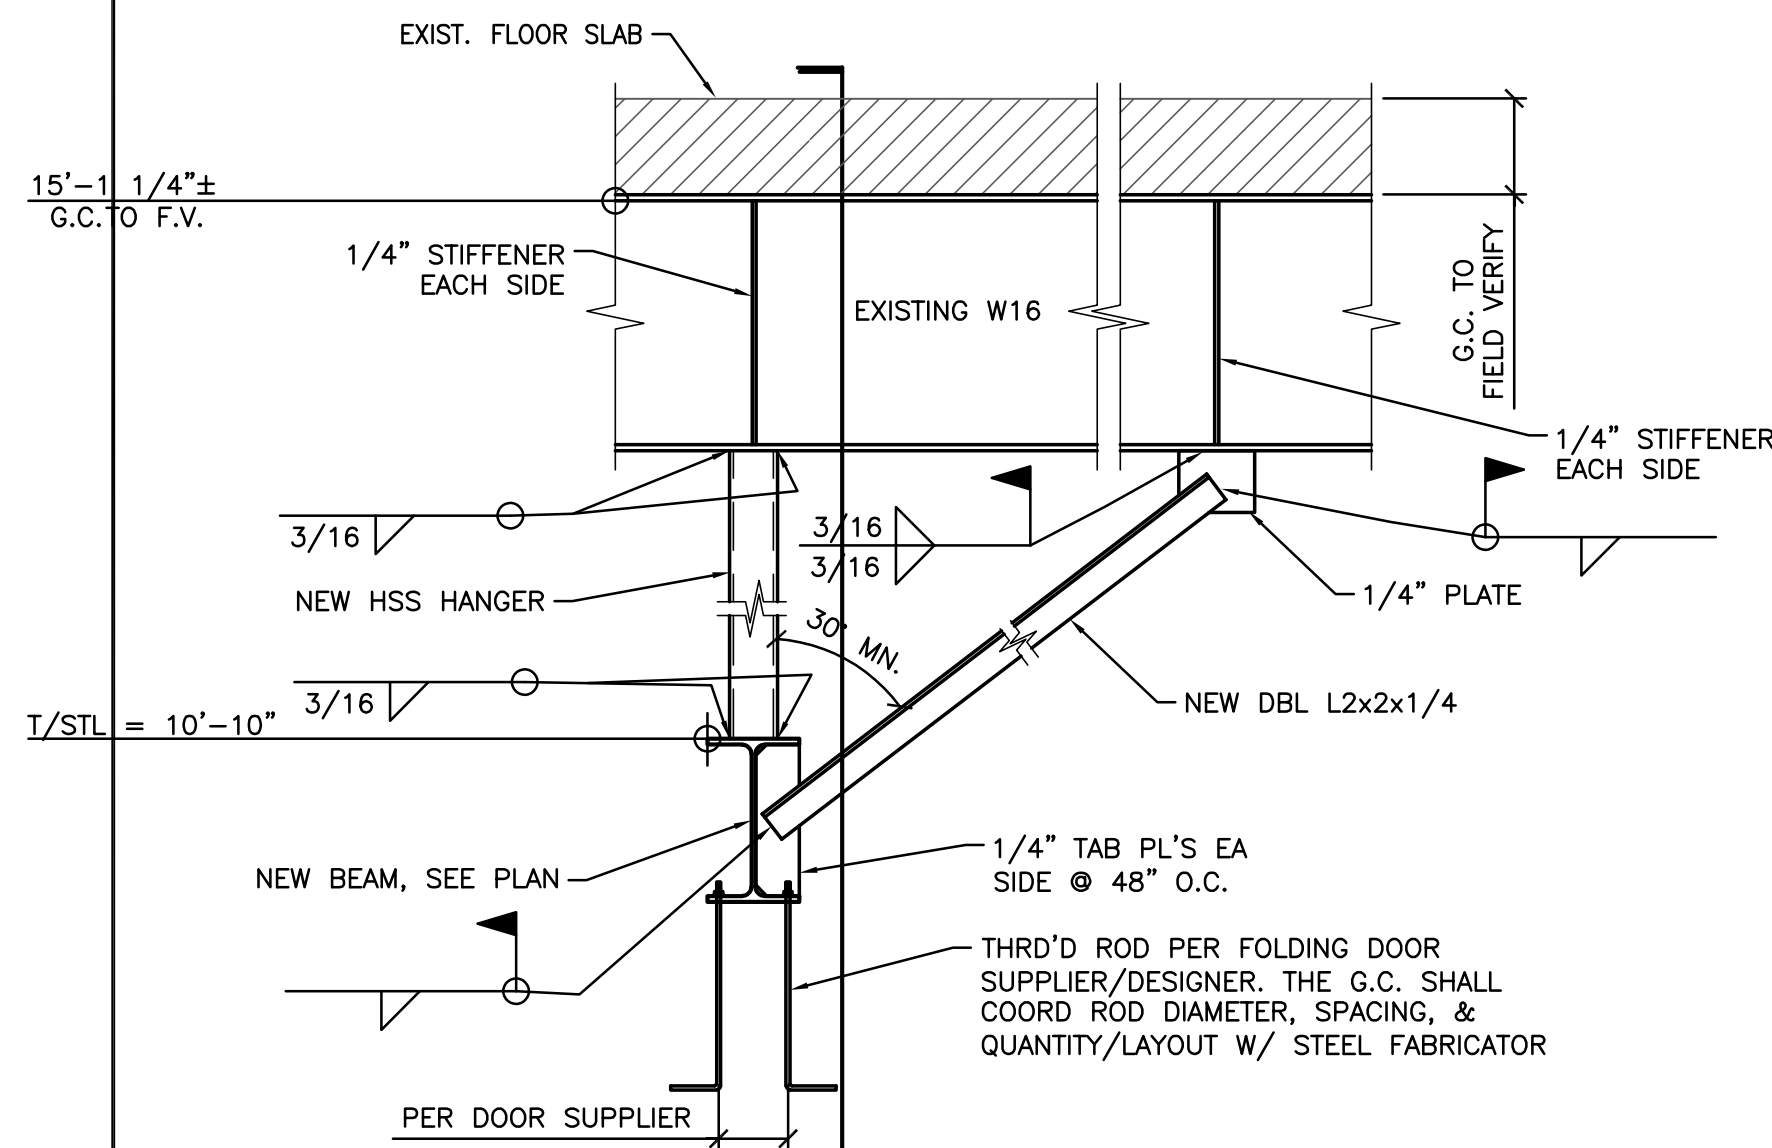


7 SECTION (TYPICAL)

SCALE: 1"=1'-0"

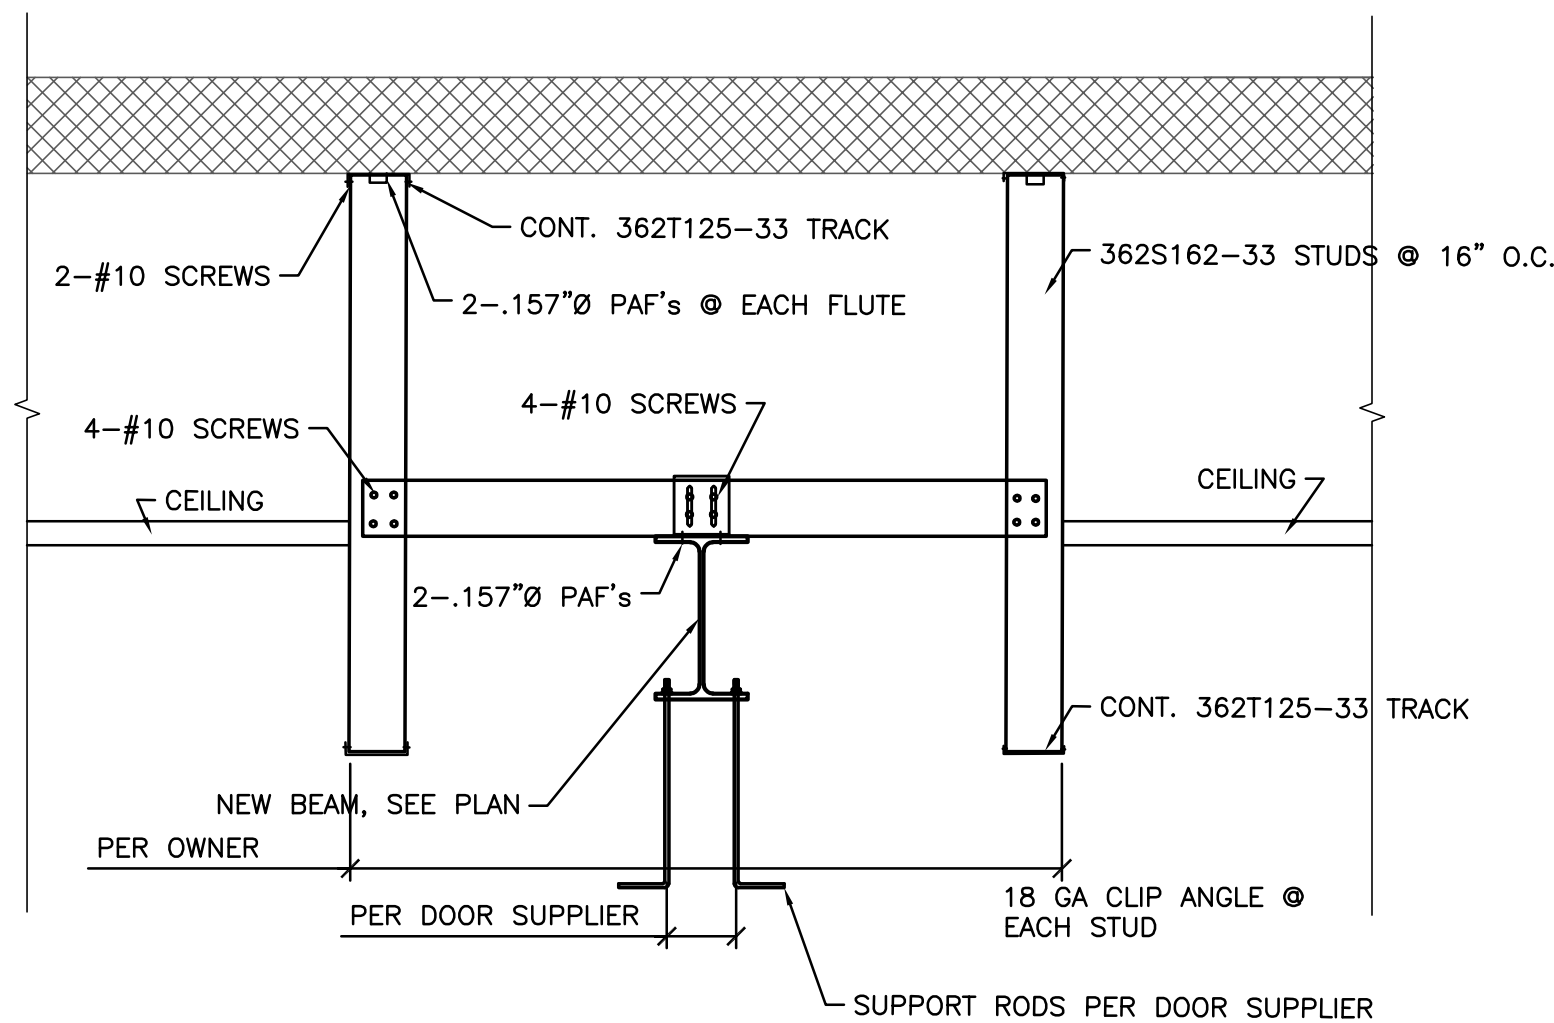

8 SECTION (TYPICAL)

SCALE: 1"=1'-0"

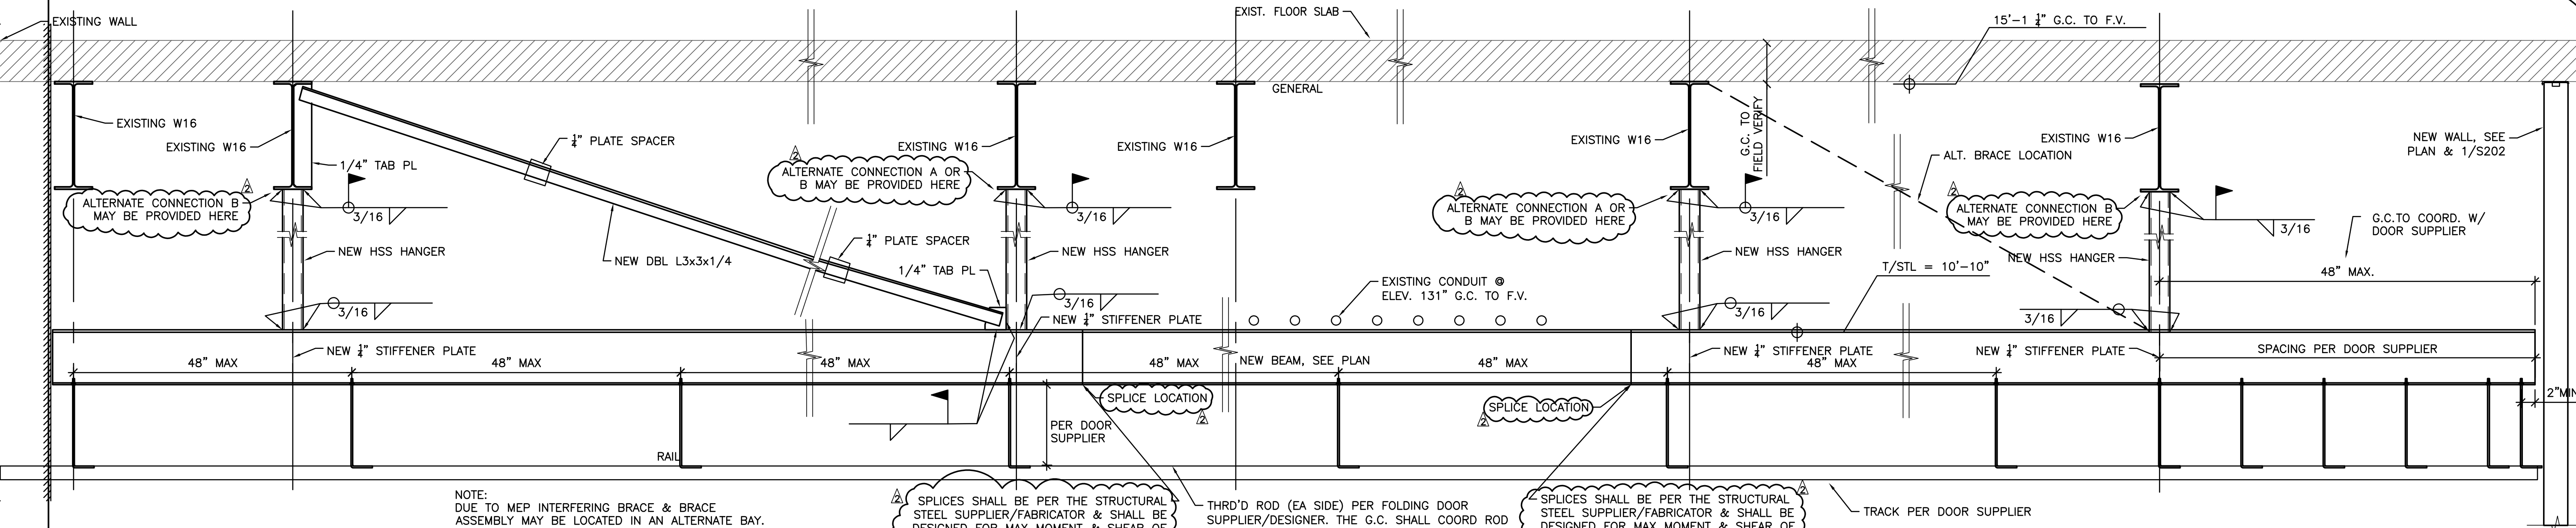

NOTE:
DUE TO MEP INTERFERING BRACE & BRACE
ASSEMBLY MAY BE LOCATED IN AN ALTERNATE BAY.

SPICES SHALL BE PER THE STRUCTURAL
STEEL SUPPLIER/FABRICATOR & SHALL BE
DESIGNED FOR MAX MOMENT & SHEAR OF
THE BEAM SECTION

THRD'D ROD (EA SIDE) PER FOLDING DOOR
SUPPLIER/DESIGNER. THE G.C. SHALL COORD ROD
DIAMETER, SPACING, & QUANTITY/LAYOUT W/ STEEL
FABRICATOR (TYP. EA. LOCATION)

SPICES SHALL BE PER THE STRUCTURAL
STEEL SUPPLIER/FABRICATOR & SHALL BE
DESIGNED FOR MAX MOMENT & SHEAR OF
THE BEAM SECTION

TRACK PER DOOR SUPPLIER



9 SECTION

SCALE: 1"=1'-0"

MUSCH CHP
Charleston, South Carolina

MUSCH CHP 1ST FLOOR FOLDING PARTITION
DOOR (ROOM 105)

CHARLESTON
SOUTH CAROLINA

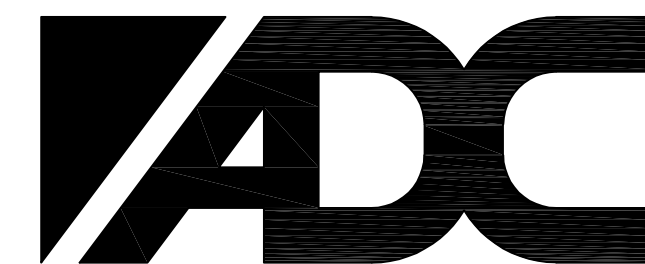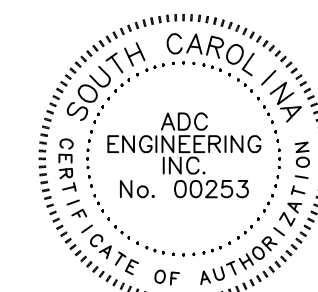

ENGINEERING SPECIALISTS

SITE SERVICES \ BUILDING ENVELOPE \ STRUCTURAL

1226 YEAMANS HALL ROAD
HANAHAN, SC 29410
843-566-0161
Fax 843-566-0162
ADCENGINEERING.COM

DATE: 4-27-2018

ADC PROJECT #: 18026.0

DESIGNED: CJG

CHECKED: CJG

DRAWN: VG

REVISION:

REVISED 09.10.2018



REVISED 01.17.2019

TYPICAL SECTIONS
AND DETAILS

S201


SHEET 3 OF 4

CONSTRUCTION DOCUMENTS

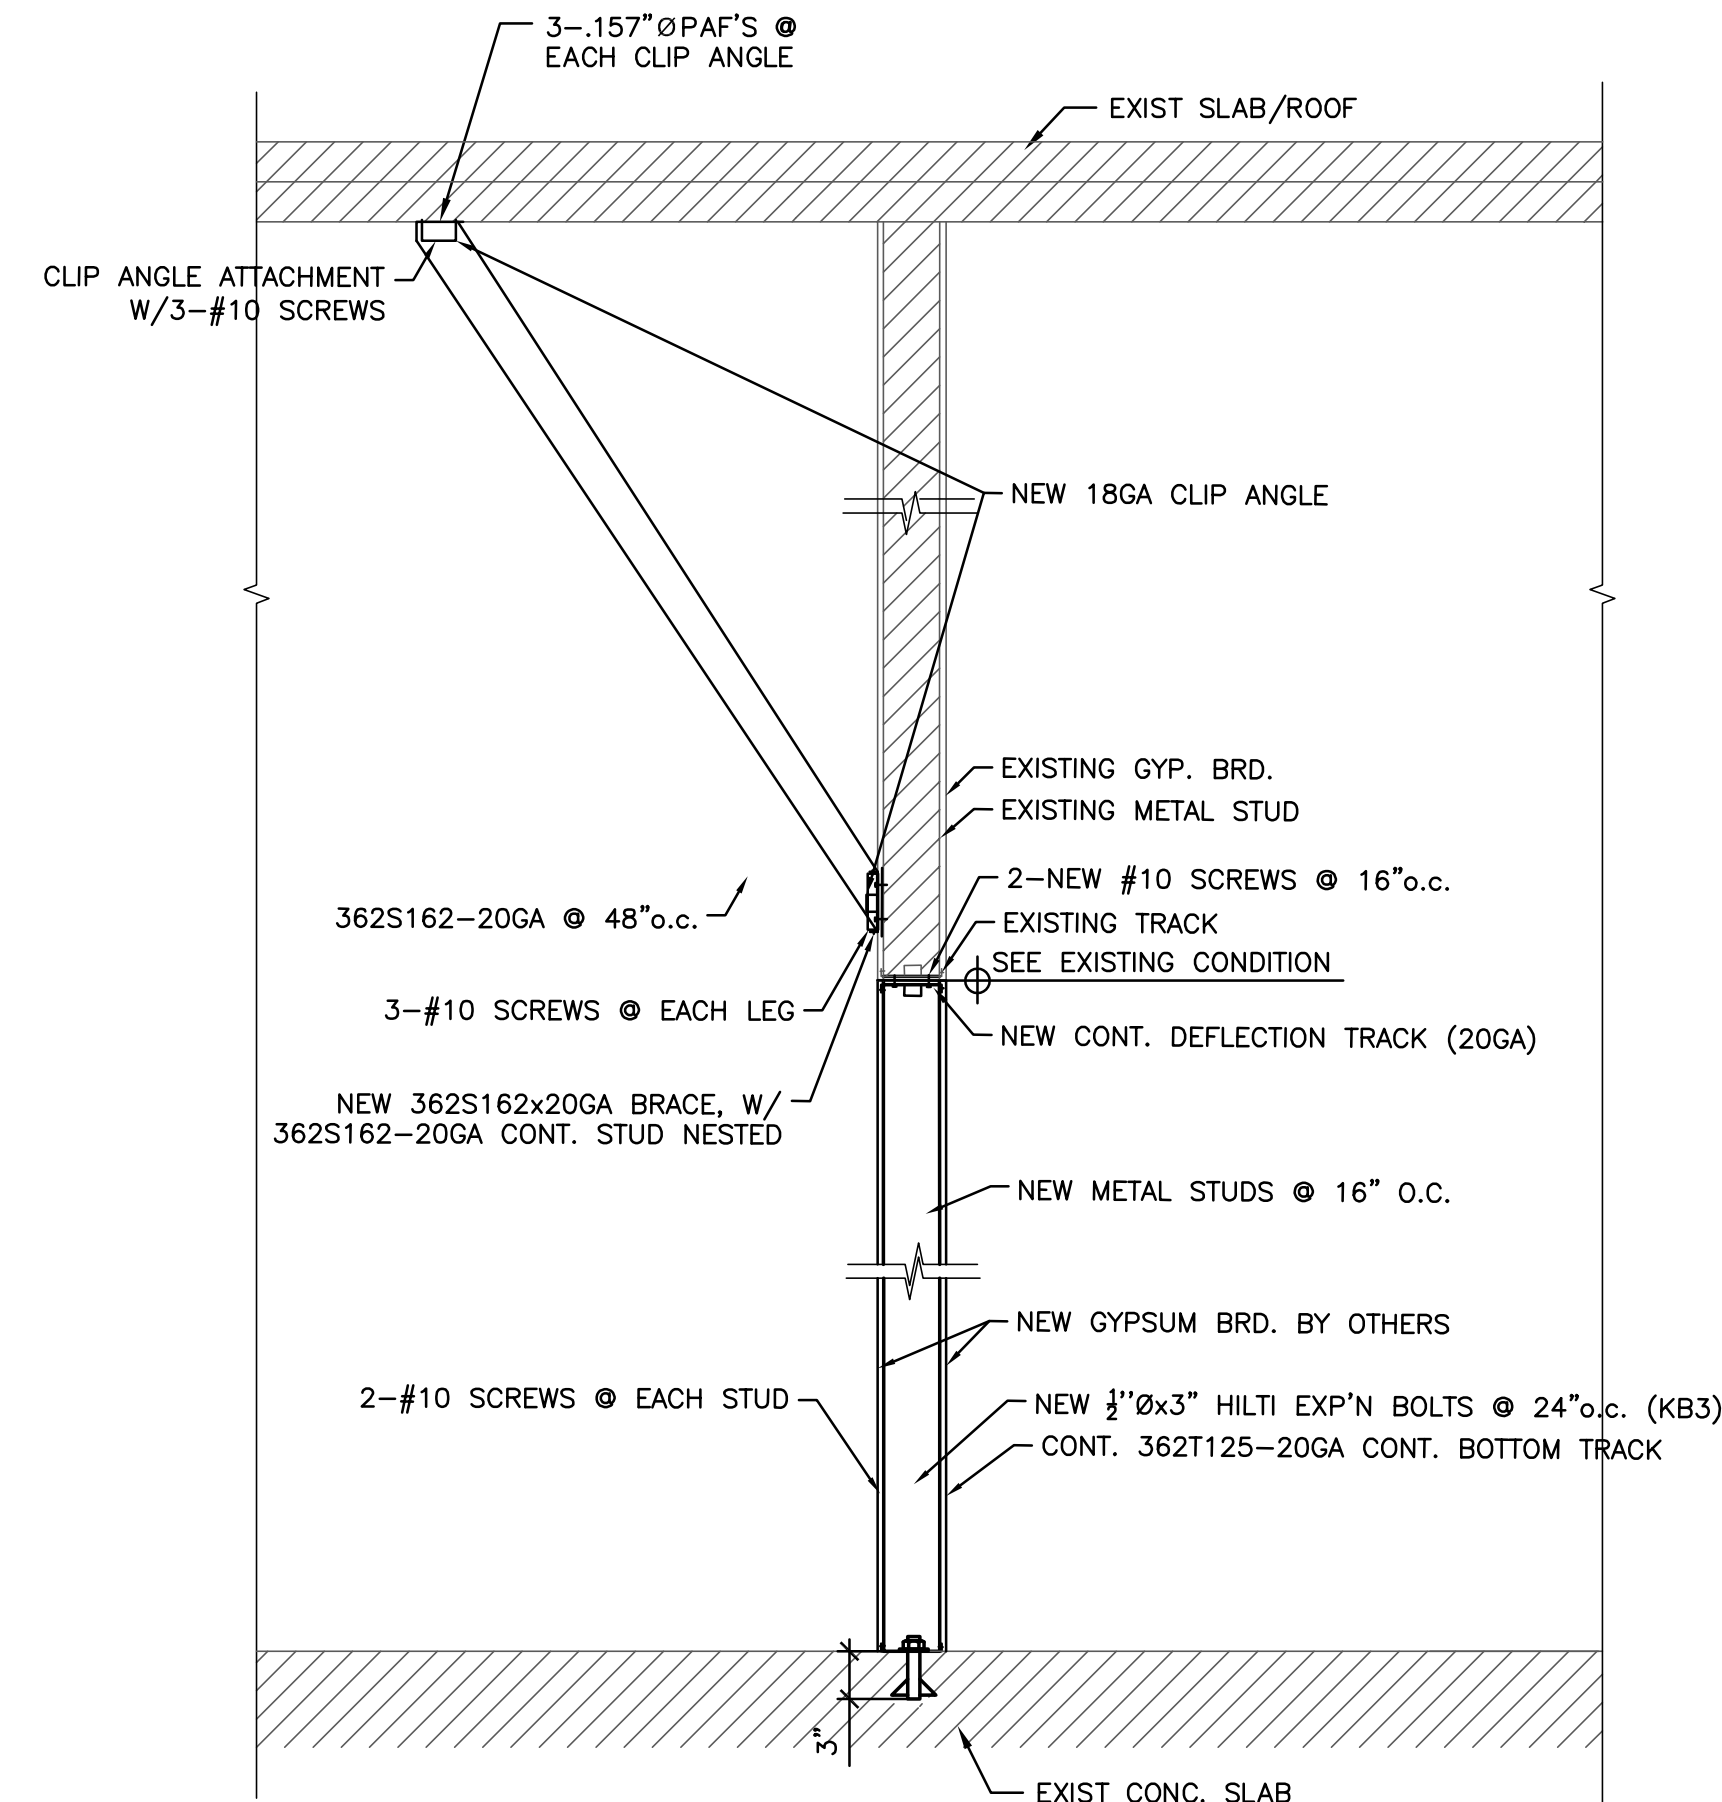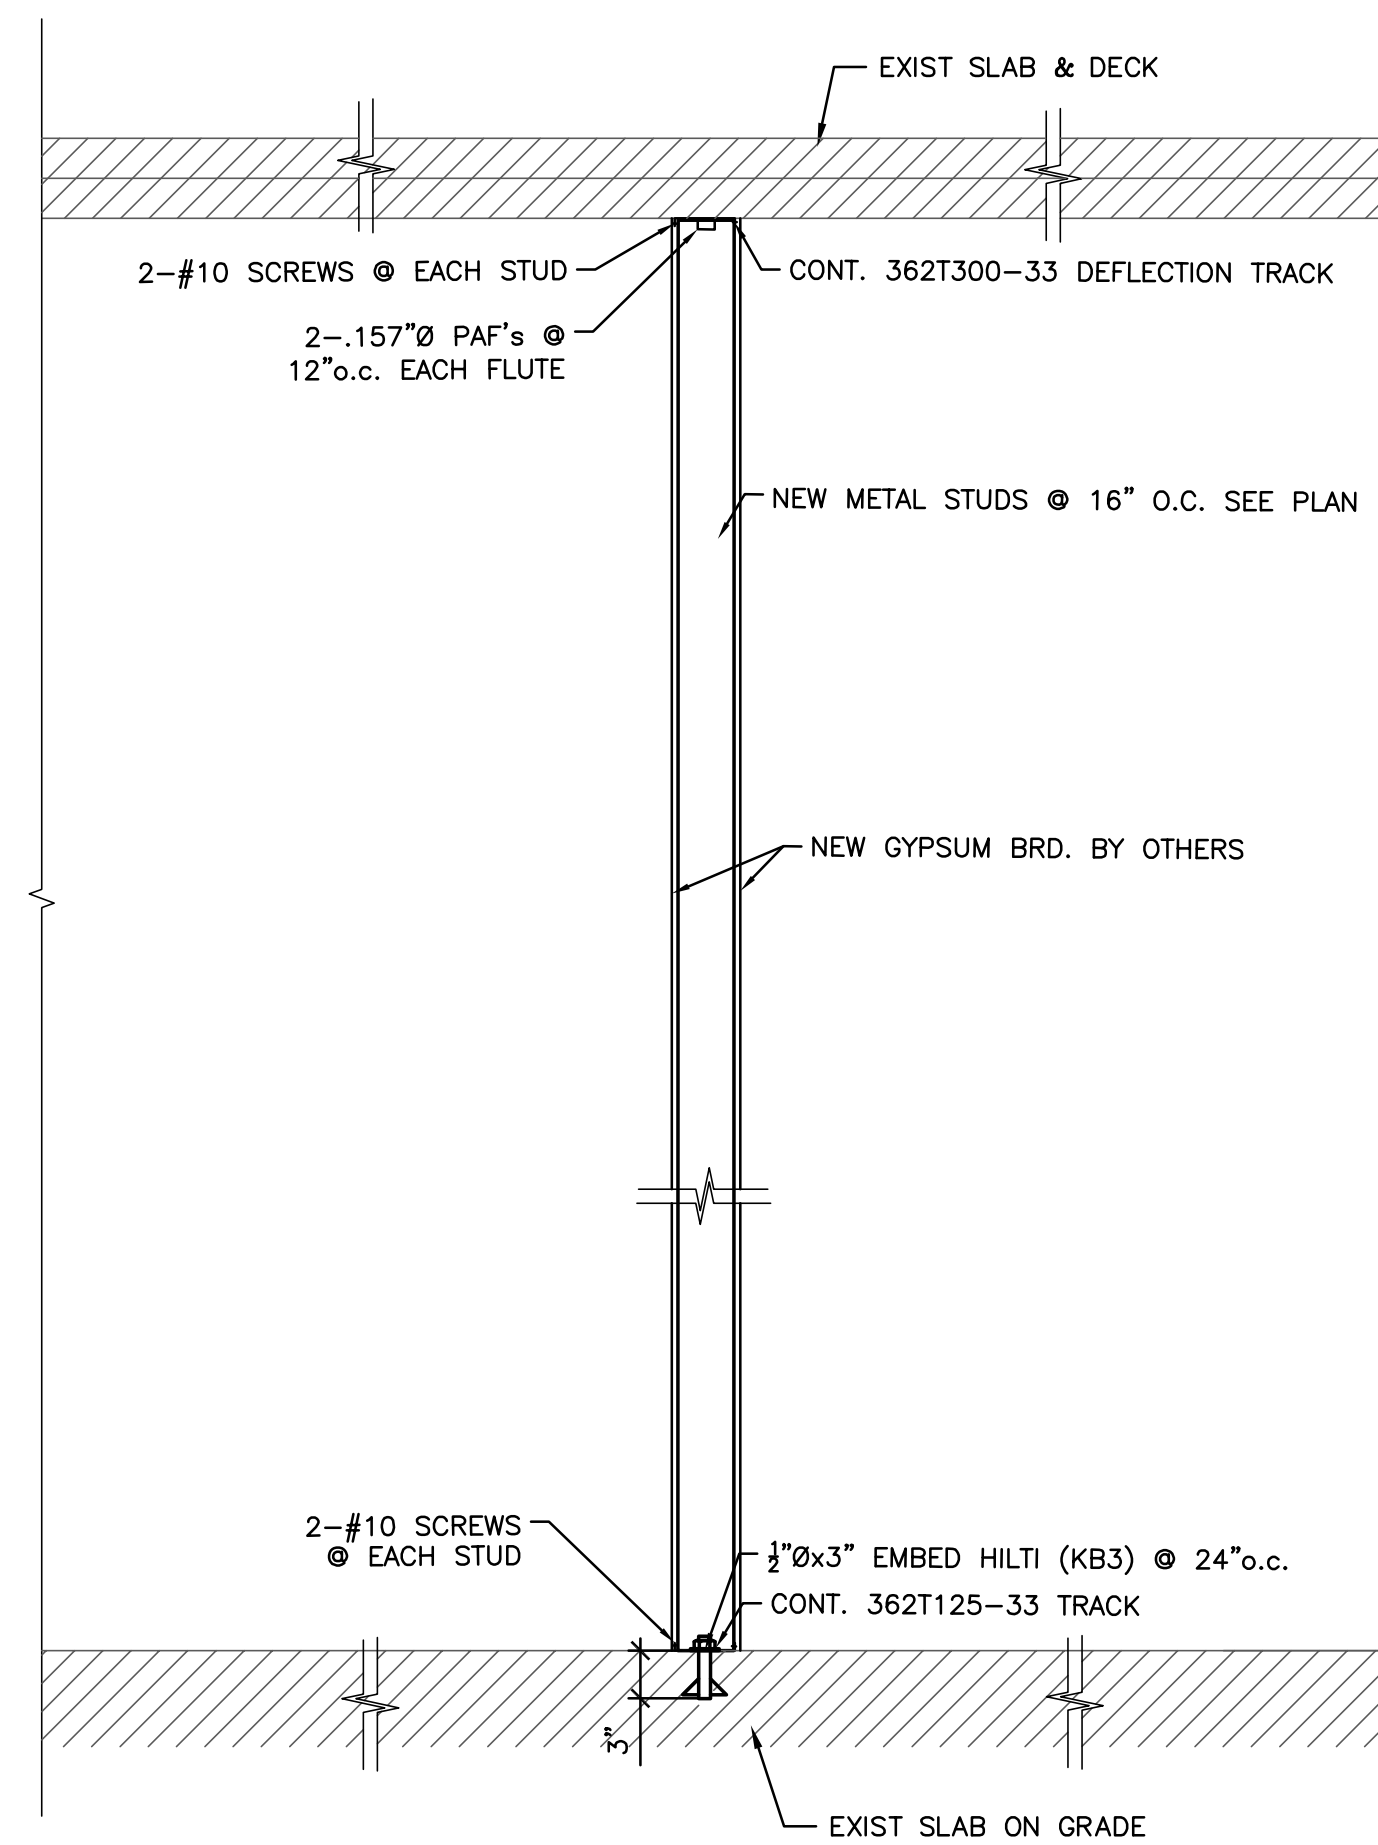

SECTION (TYPICAL)


SCALE: 1"=1'-0"

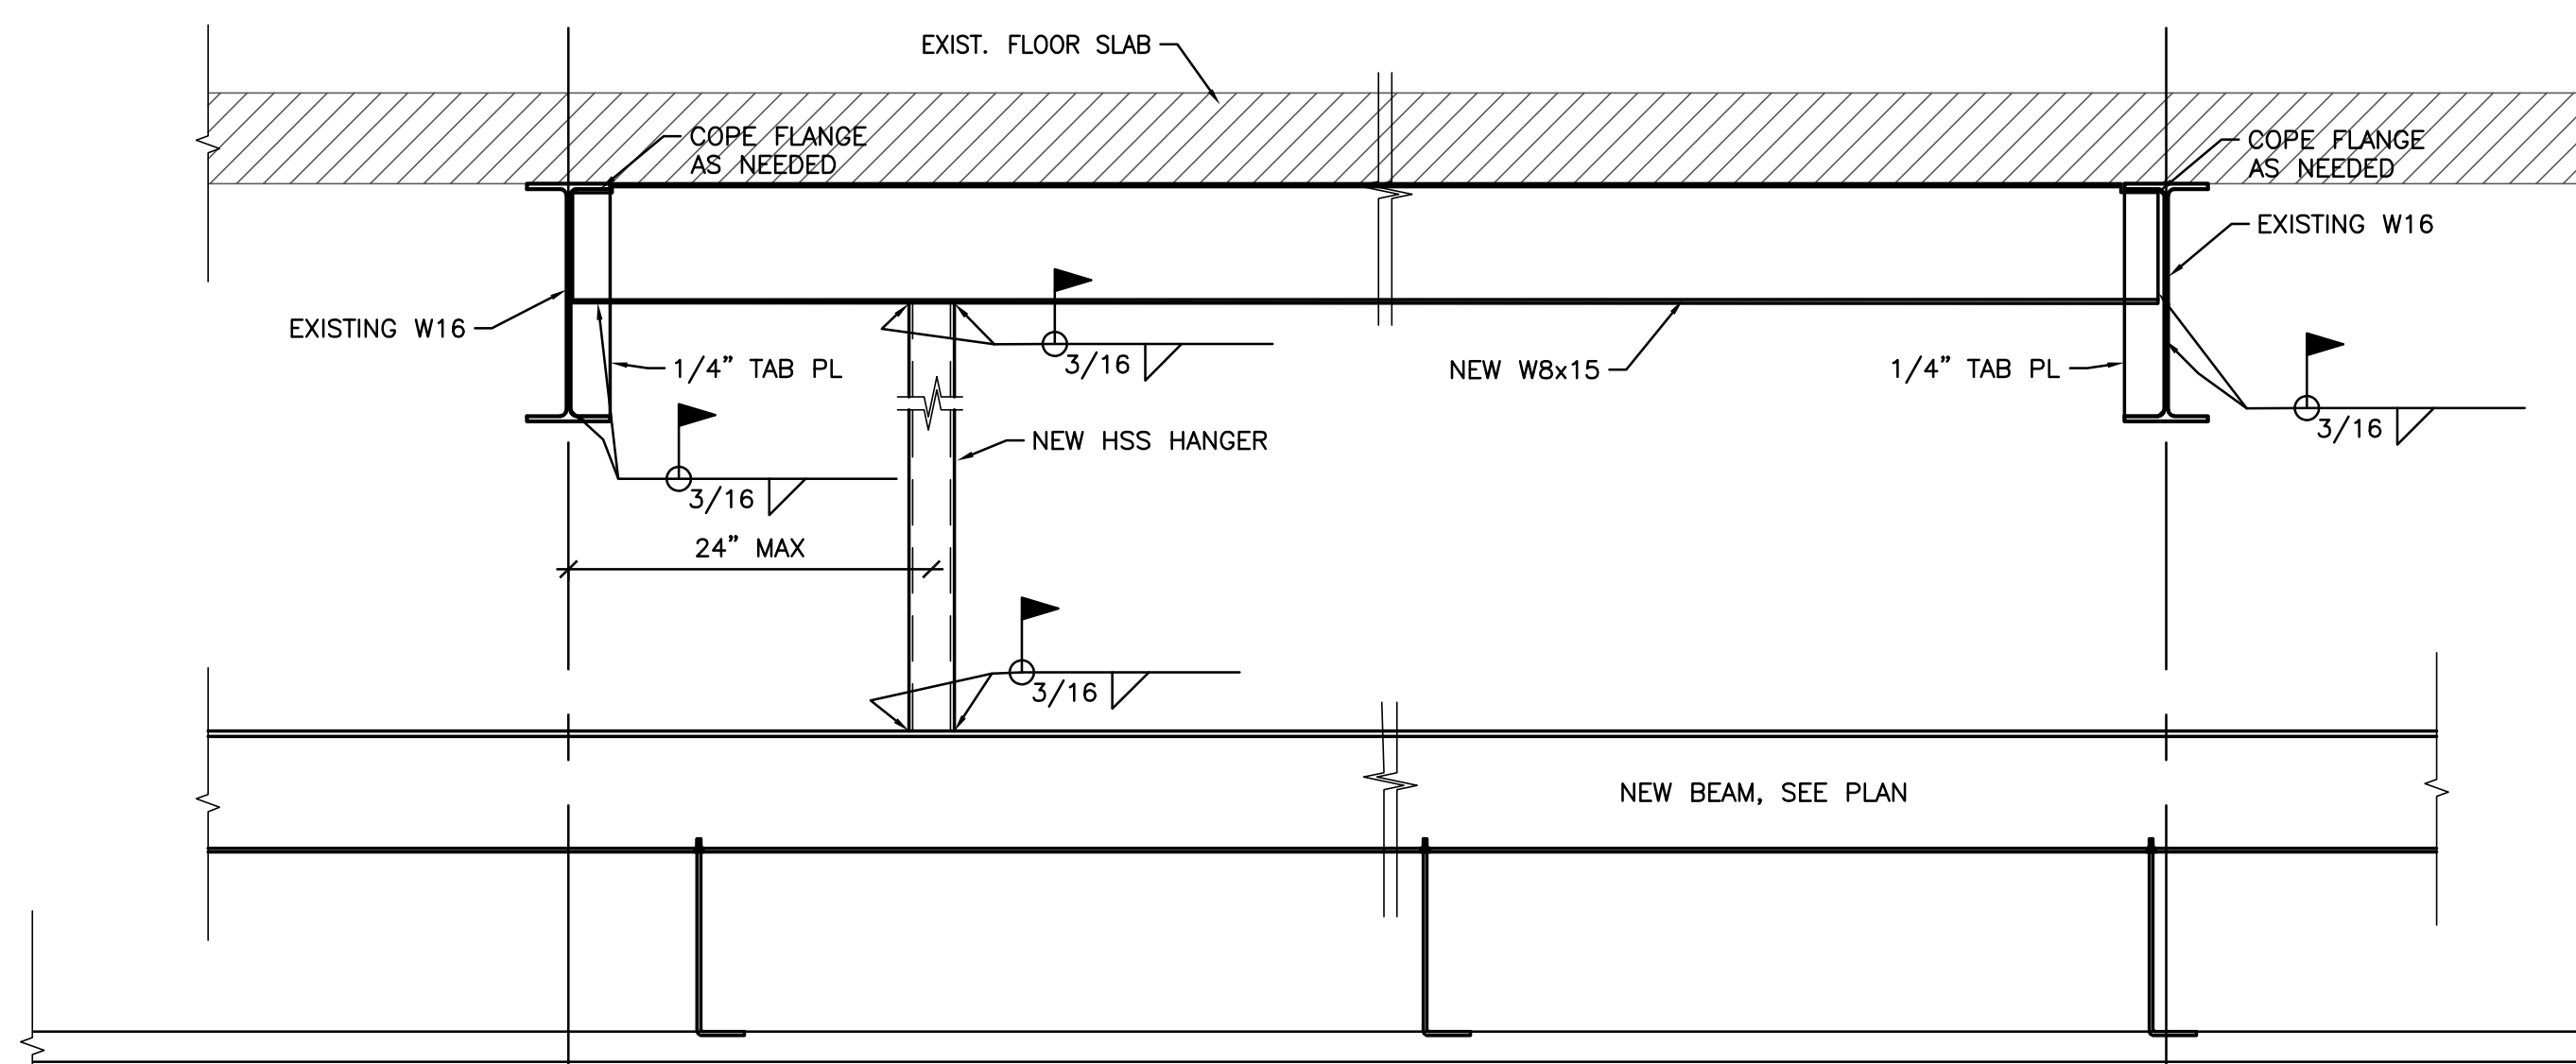

SECTION (TYPICAL)

~~S202~~

SCALE: $1'' = 1' - 0''$

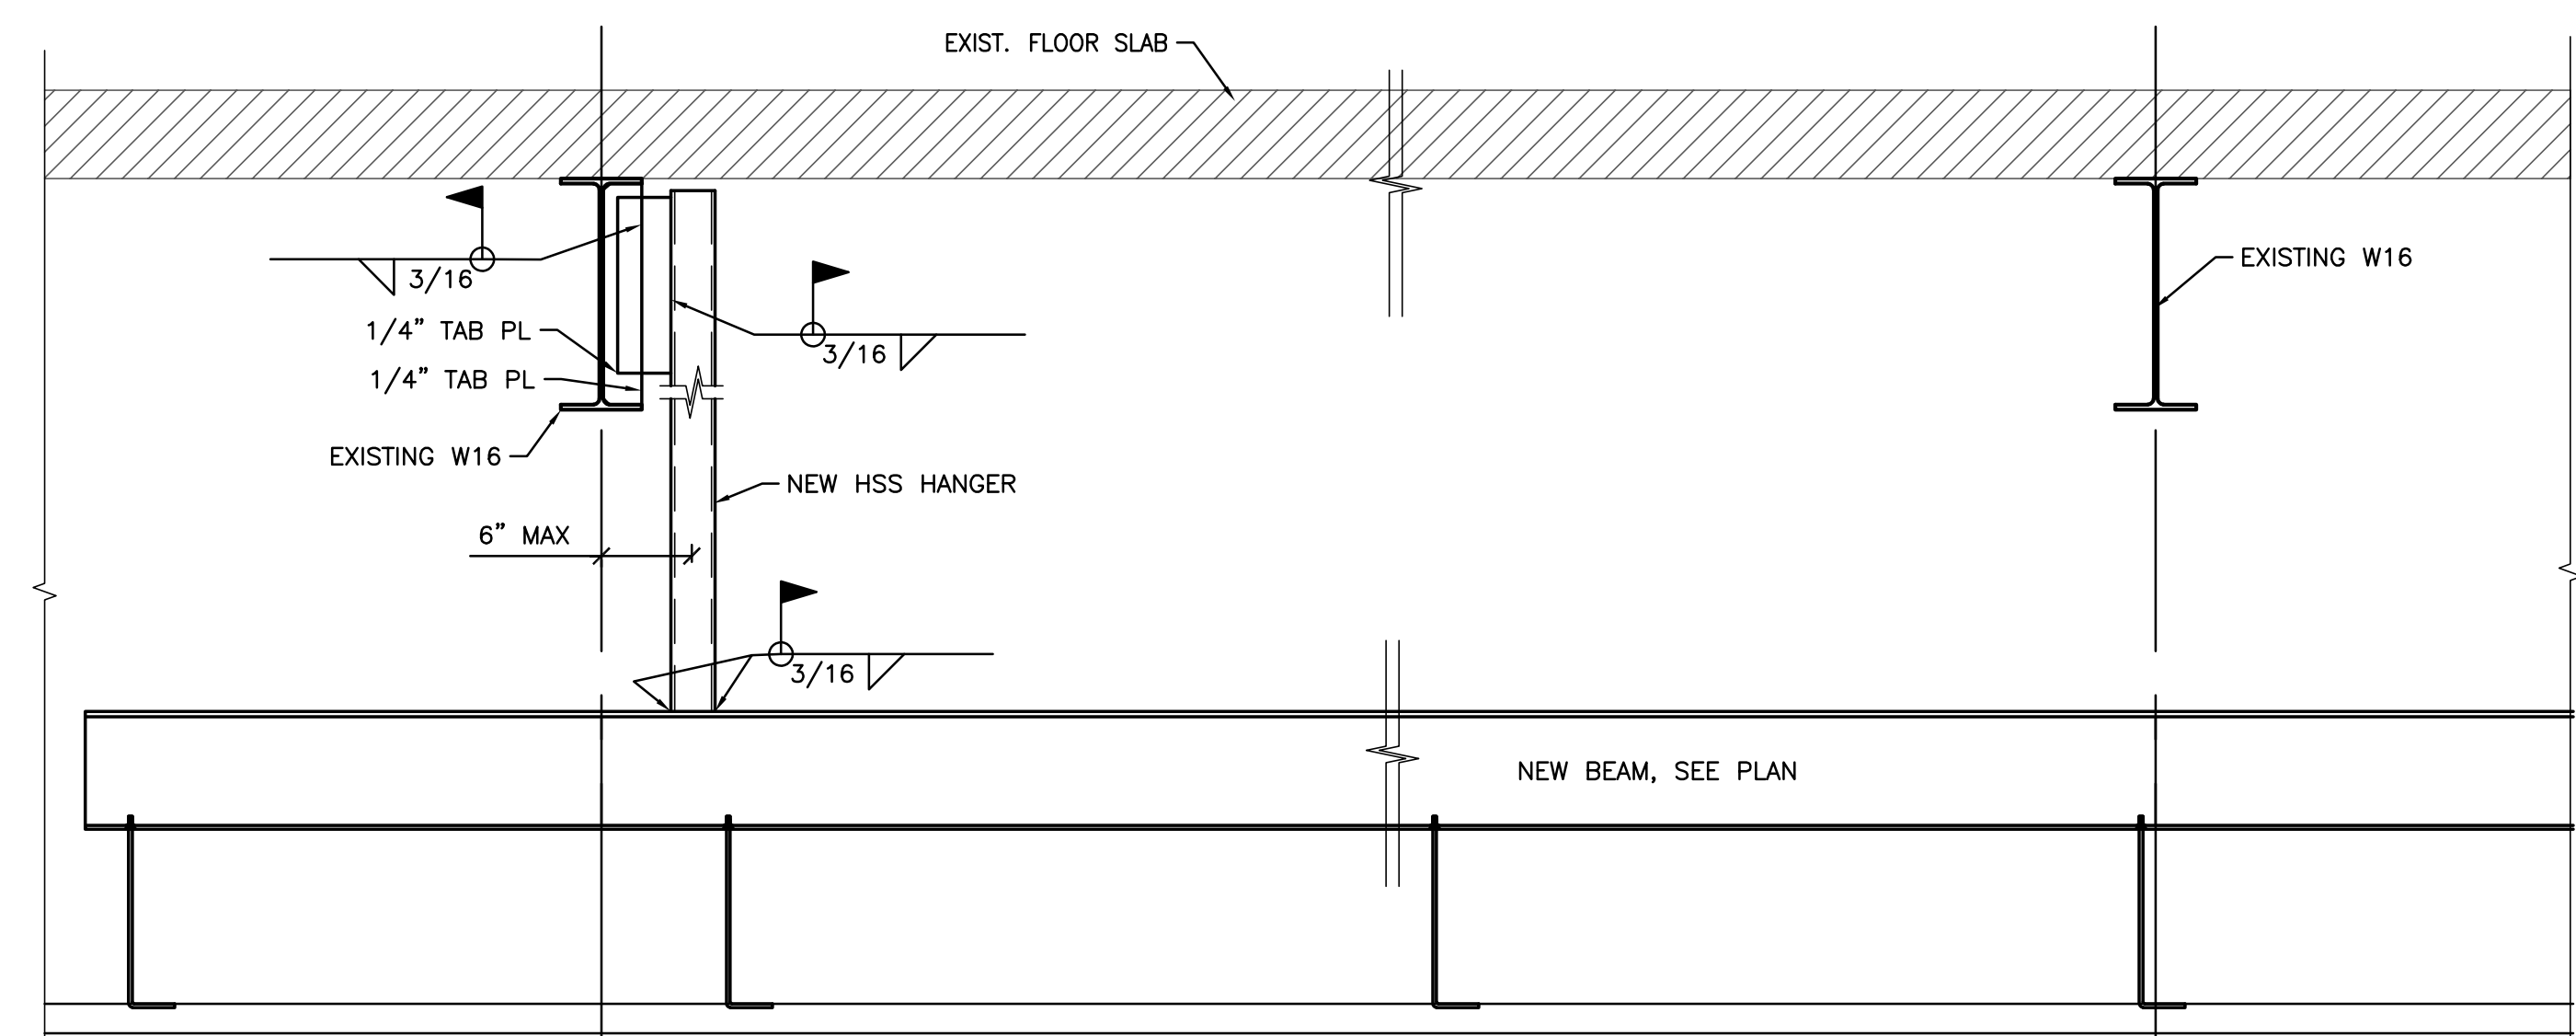

3 ALTERNATE POST TO EXISTING STRUCTURE ATTACHMENT DETAIL

3




SCALE: 1"=1'-0"

CONSTRUCTION DOCUMENTS

MUSCH CHP
Charleston, South Carolina

MUSC CHP 1ST FLOOR FOLDING PARTITION
DOOR (ROOM 105)

CHARLESTON
SOUTH CAROLINA

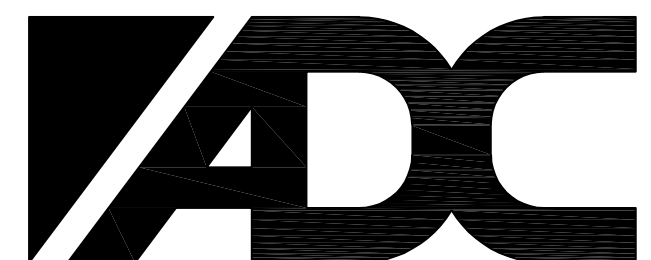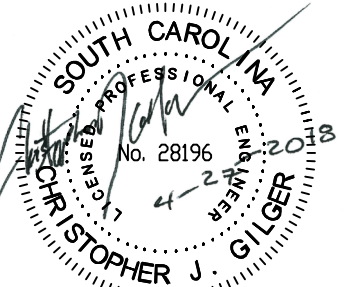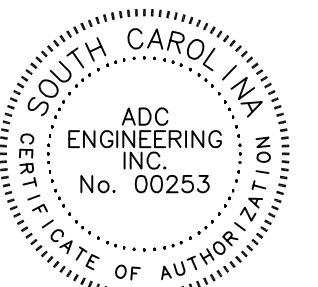

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ADCENGINEERING.COM**

DATE: 4-27-2018

ADC PROJECT #: 18026.0

DESIGNED: C J G

CHECKED: CJG

DRAWN: _____ VG

REVISION: _____

2 REVISED 01.17.2019

TYPICAL SECTIONS AND DETAILS

§202

SHEET 4 OF 4